No. 23-001 | 92 & 94 Lancaster Ave Punchbowl NSW

RESIDENTIAL DEVELOPMENT

DA SUBMISSION



COMPLIANCE TABLE - BANKSTOWN LEP & DCP (SUBDIVISION)							
LOT SIZE (In Total)	1872.4 m ² (No.92: 936.2m ² ;No.94: 936.2m ²)						
	REQUIREMENT	PROPOSED	COMPLY				
LOT SIZE (DUAL OCCUPANCY)	MIN 500m ² & 15m FRONTAGE (ATTACHED) OR MIN 700m ² & 20m FRONTAGE (DETACHED)	LOT A: 714m ² , 20.78m FRONTAGE;	YES				
LOT SIZE (SINGLE DWELLING)	MIN 450 m ²	LOT B: 450m ² ; LOT C: 500m ²	YES				

LOT SIZE (In Total)	450.0 m²			
		REQUIREMENT	PROPOSED	COMPLY
FSR: 0.5:1	MAX	225 m²	156 m²	YES
HEIGHT	MAX	9 m	<9m	YES
LANDSCAPE FORWARD OF BUILDING LINE: 45% of the area of the lot forward of the building line	MIN	26.8 m²	46 m²	YES
PRIMARY ROAD SETBACK	MIN	5.5m for GF 6.5m for FF	N/A	
SIDE SETBACK	MIN	0.9m, WALL<7m 1.5m, WALL>7m	0.9m; 1.5m	YES
POS	MIN	80 m ² & MIN 5m WIDTH	80 m²	YES
CAR SPACES		2	2	YES
LOT SIZE (In Total)	500.0 m ²		22020052	601401
		REQUIREMENT	PROPOSED	COMPLY
FSR: 0.5:1	MAX	250 m²	164 m²	YES
HEIGHT	MAX	9 m	<9m	YES
LANDSCAPE FORWARD OF BUILDING LINE: 45% of the area of the lot forward of the building line	MIN	64.9 m²	74 m²	YES
PRIMARY ROAD SETBACK	MIN	5.5m for GF 6.5m for FF	N/A	
SIDE SETBACK	MIN	0.9m, WALL<7m 1.5m, WALL>7m	1.5 m	YES
POS	MIN	80 m ² & MIN 5m WIDTH	103 m ²	YES
105		<u> </u>		

COMPLIANCE TABLE - BANKSTOWN LEP & DCP (DUAL- OCCUPANCY - Lot A)								
LOT SIZE (In Total)	714.0 m ²							
	REQUIREMENT	PROPOSED	COMPLY					
FSR: 0.5:1	MAX 357 m ²	350 m²	YES					
HEIGHT	MAX 9 m	<8.5m	YES					
LANDSCAPE FORWARD OF BUILDING LINE: 45% of the area of the lot forward of the building line	MIN 51.7 m²	77 m²	YES					
PRIMARY ROAD SETBACK	MIN 5.5m for GF 6.5m for FF	5.5m GF; 6.5m FF	YES					
SIDE SETBACK	MIN 0.9m, WALL<7m 1.5m, WALL>7m	0.9m & 1.5m	YES					
POS	MIN 80 m ² & MIN 5m WIDTH	160 m²	YES					
CAR SPACES	2 SPACES > 3 BEDROOMS	2	YES					

SITE FLOOR PLA ELEVATION SECTIONS COMPLIENC

EXTERNAL

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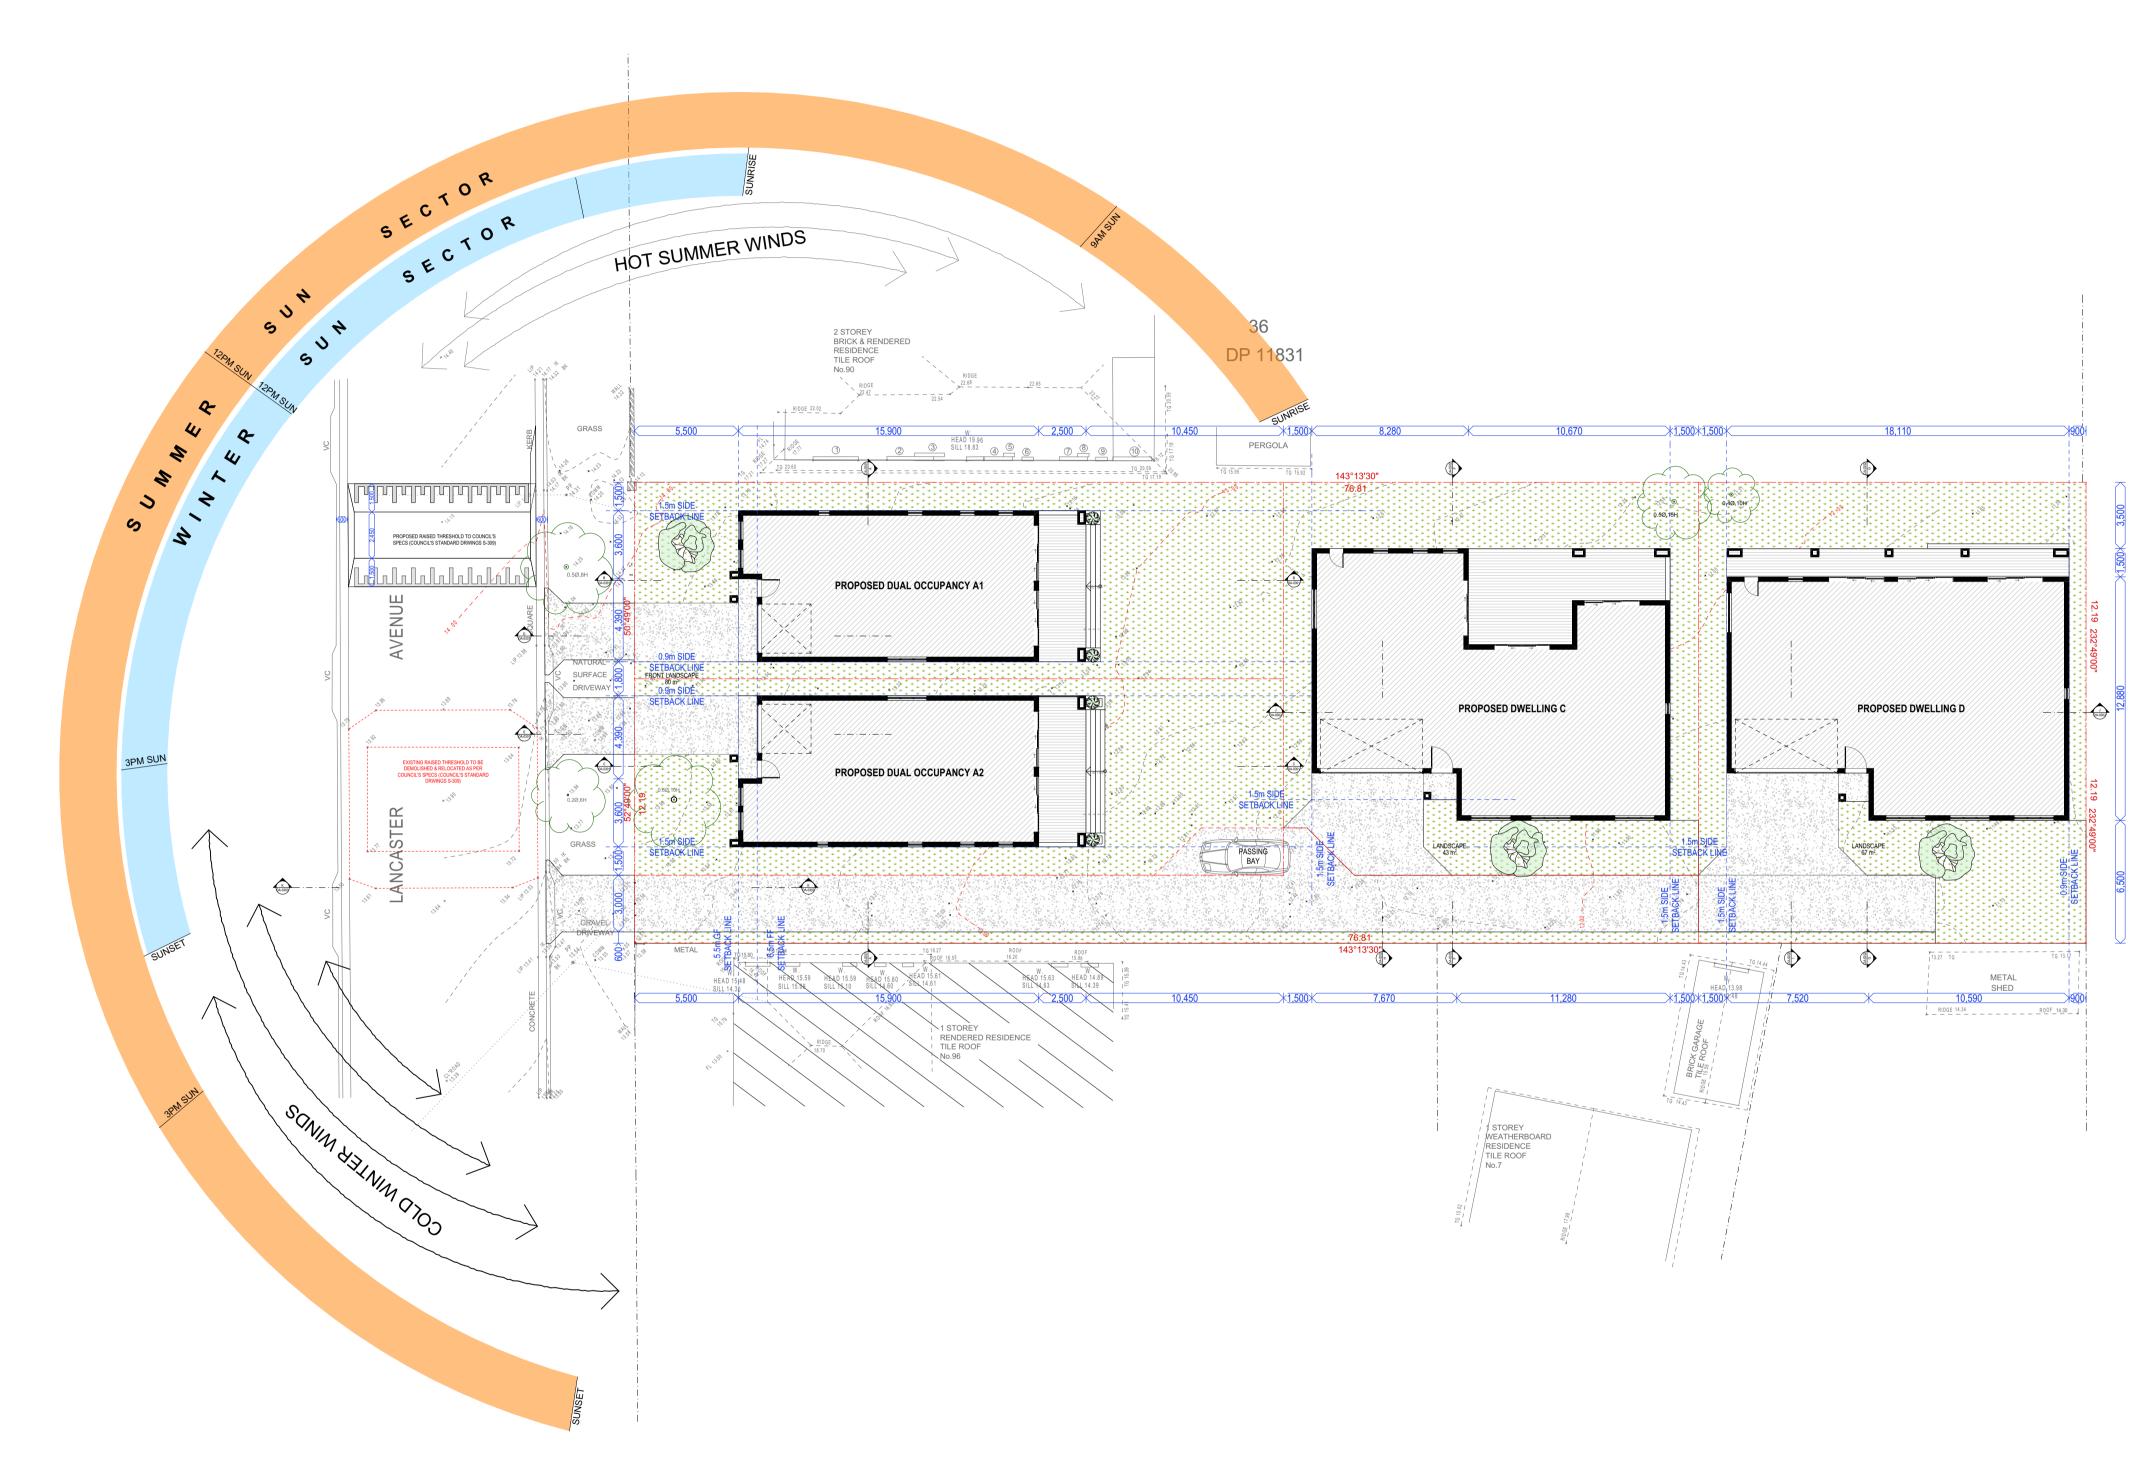
	DEVELOPMENT APPLICATION	Revision
	Layout Name	Revision
DA-0000	COVER	В
DA-0001	SITE PLAN & ANALYSIS	В
DA-0002	DEMOLITION PLAN	В
DA-0003	SUBDIVISION PLAN	В
DA-0004	SUBDIVISION PLAN - STORMWATER DRAINAGE EASEMENT	В
ANS .		
DA-0101	GROUND FLOOR	В
DA-0102	LEVEL 1	В
DA-0103	ROOF	В
IS		
DA-0201	ELEVATIONS 01 - DUAL OCCUPANCY	В
DA-0202	ELEVATIONS 02 - DUAL OCCUPANCY	В
DA-0203	ELEVATIONS 03 - DWELLINGS	В
DA-0204	ELEVATIONS 04 - DWELLINGS	В
DA-0205	STREET SCAPE	В
DA-0301	SECTIONS - DUAL OCCUPANCY	В
DA-0302	SECTIONS - DWELLINGS	В
DA-0303	SECTIONS - ACCESS HANDEL	В
CE		
DA-0401	GFA DIAGRAMS	В
DA-0402	SHADOW DIAGRAMS WINTER	В
DA-0403	VIEW FROM THE SUN 01	В
DA-0404	VIEW FROM THE SUN 02	В
DA-0405	BASIX COMMITMENTS 01	В
DA-0406	BASIX COMMITMENTS 02	В
DA-0407	BASIX COMMITMENTS 03	В
DA-0408	BASIX COMMITMENTS 04	В
DA-0409	NEIGHBOUR NOTIFICATION PLAN	В
FINISHES		
DA-0501	FINISHES SCHEDULE	В



RESIDENTIAL DEVELOPMENT

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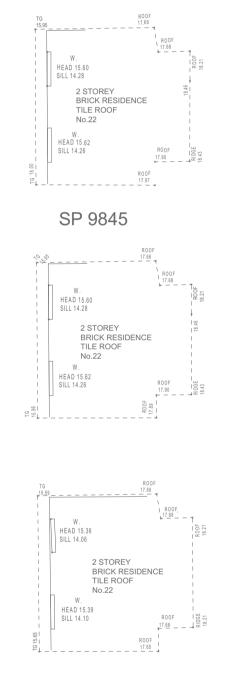


SITE PLAN SCALE 1:200

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1:200 Project Number


23-001

Status

@A1 Sheet Size

Revision В

Drawing Number

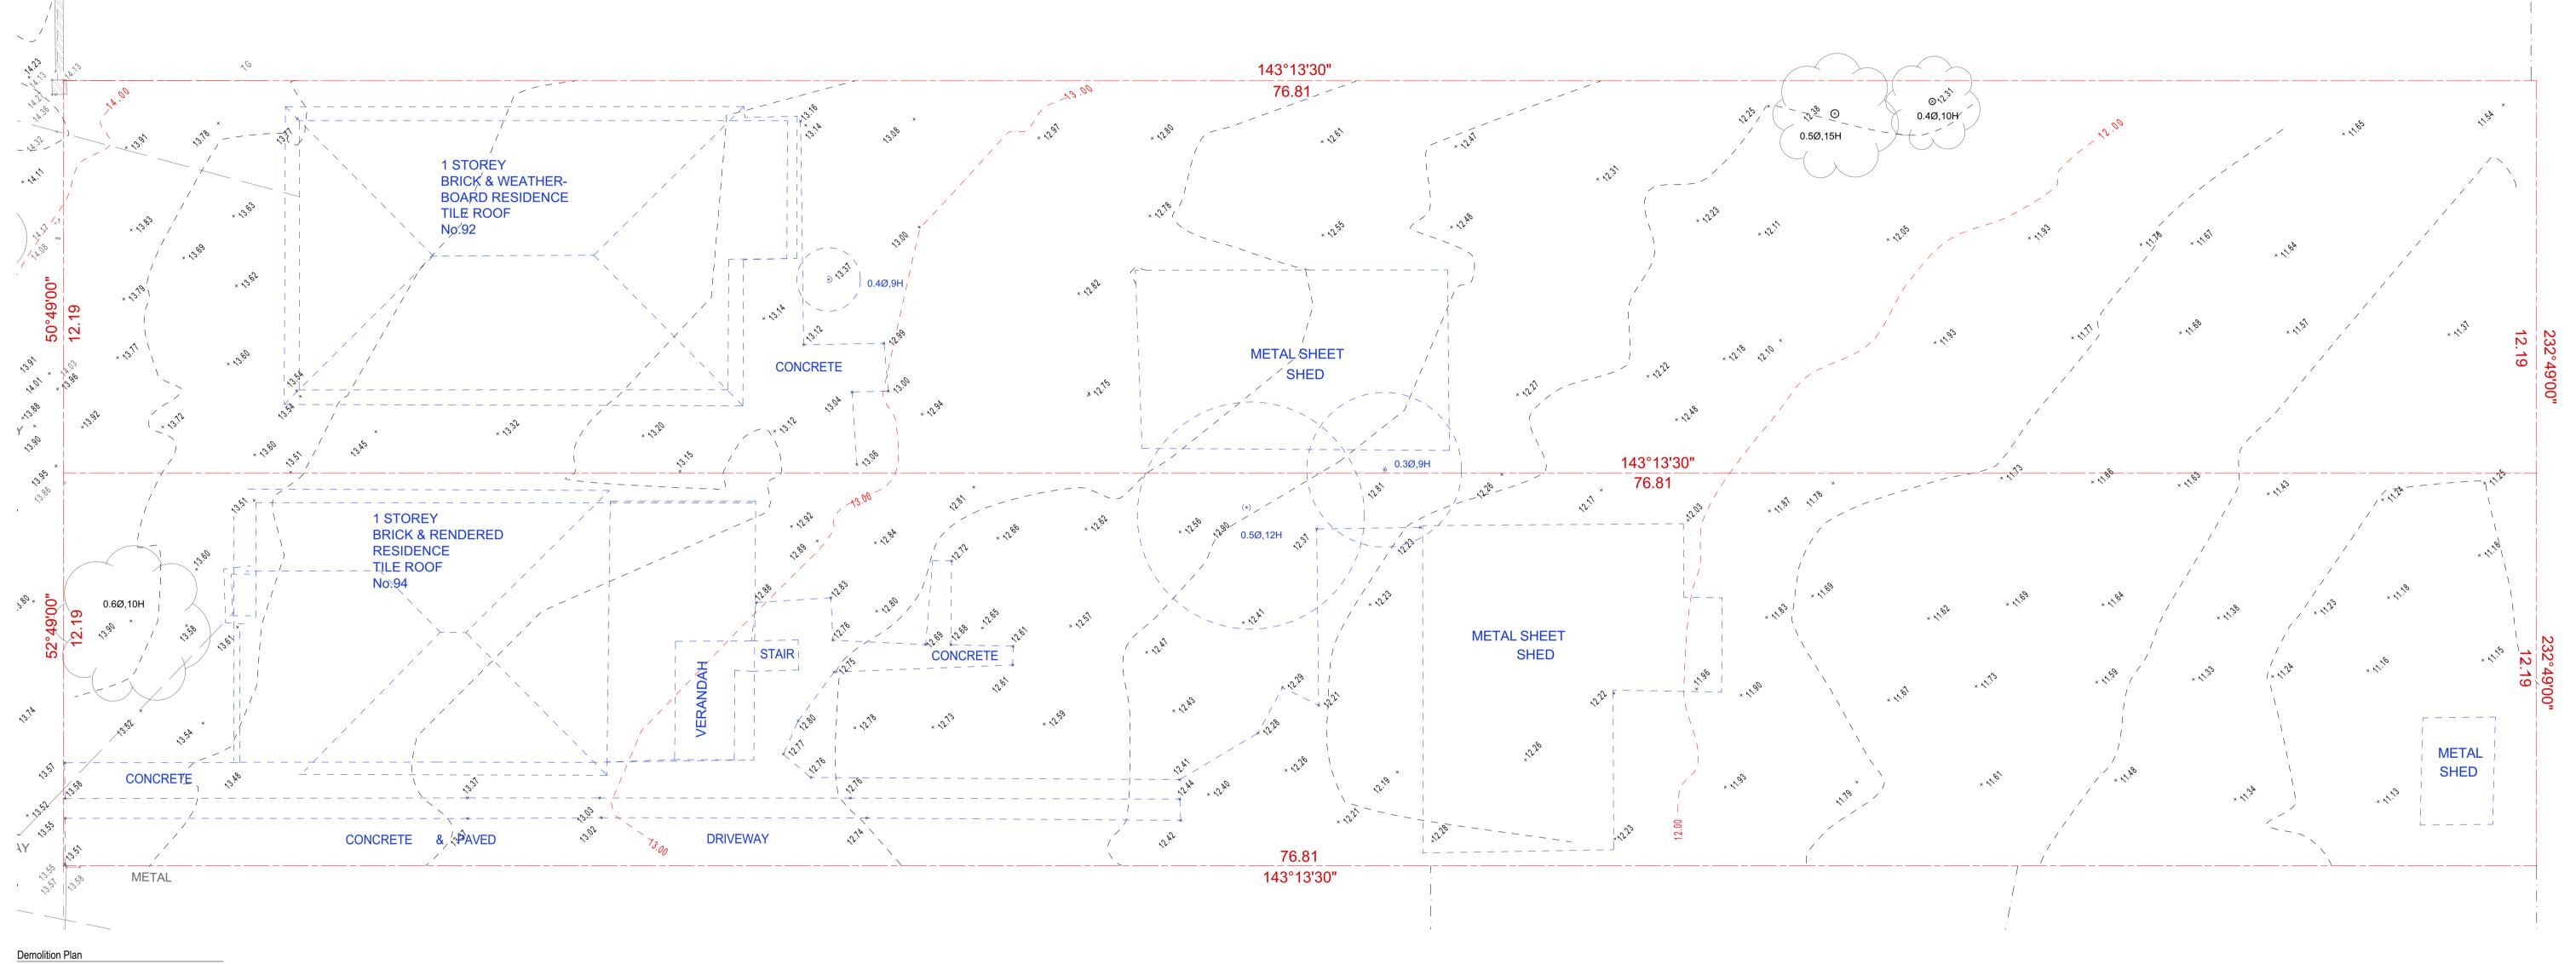

SCALE 1:100

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EXISTING STRUCTURES & TREES TO BE DEMOLISHED

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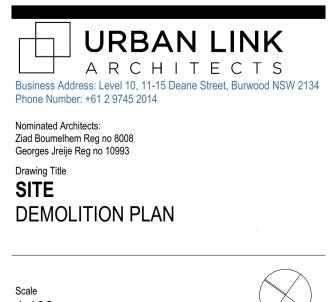
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1:100 Project Number 23-001


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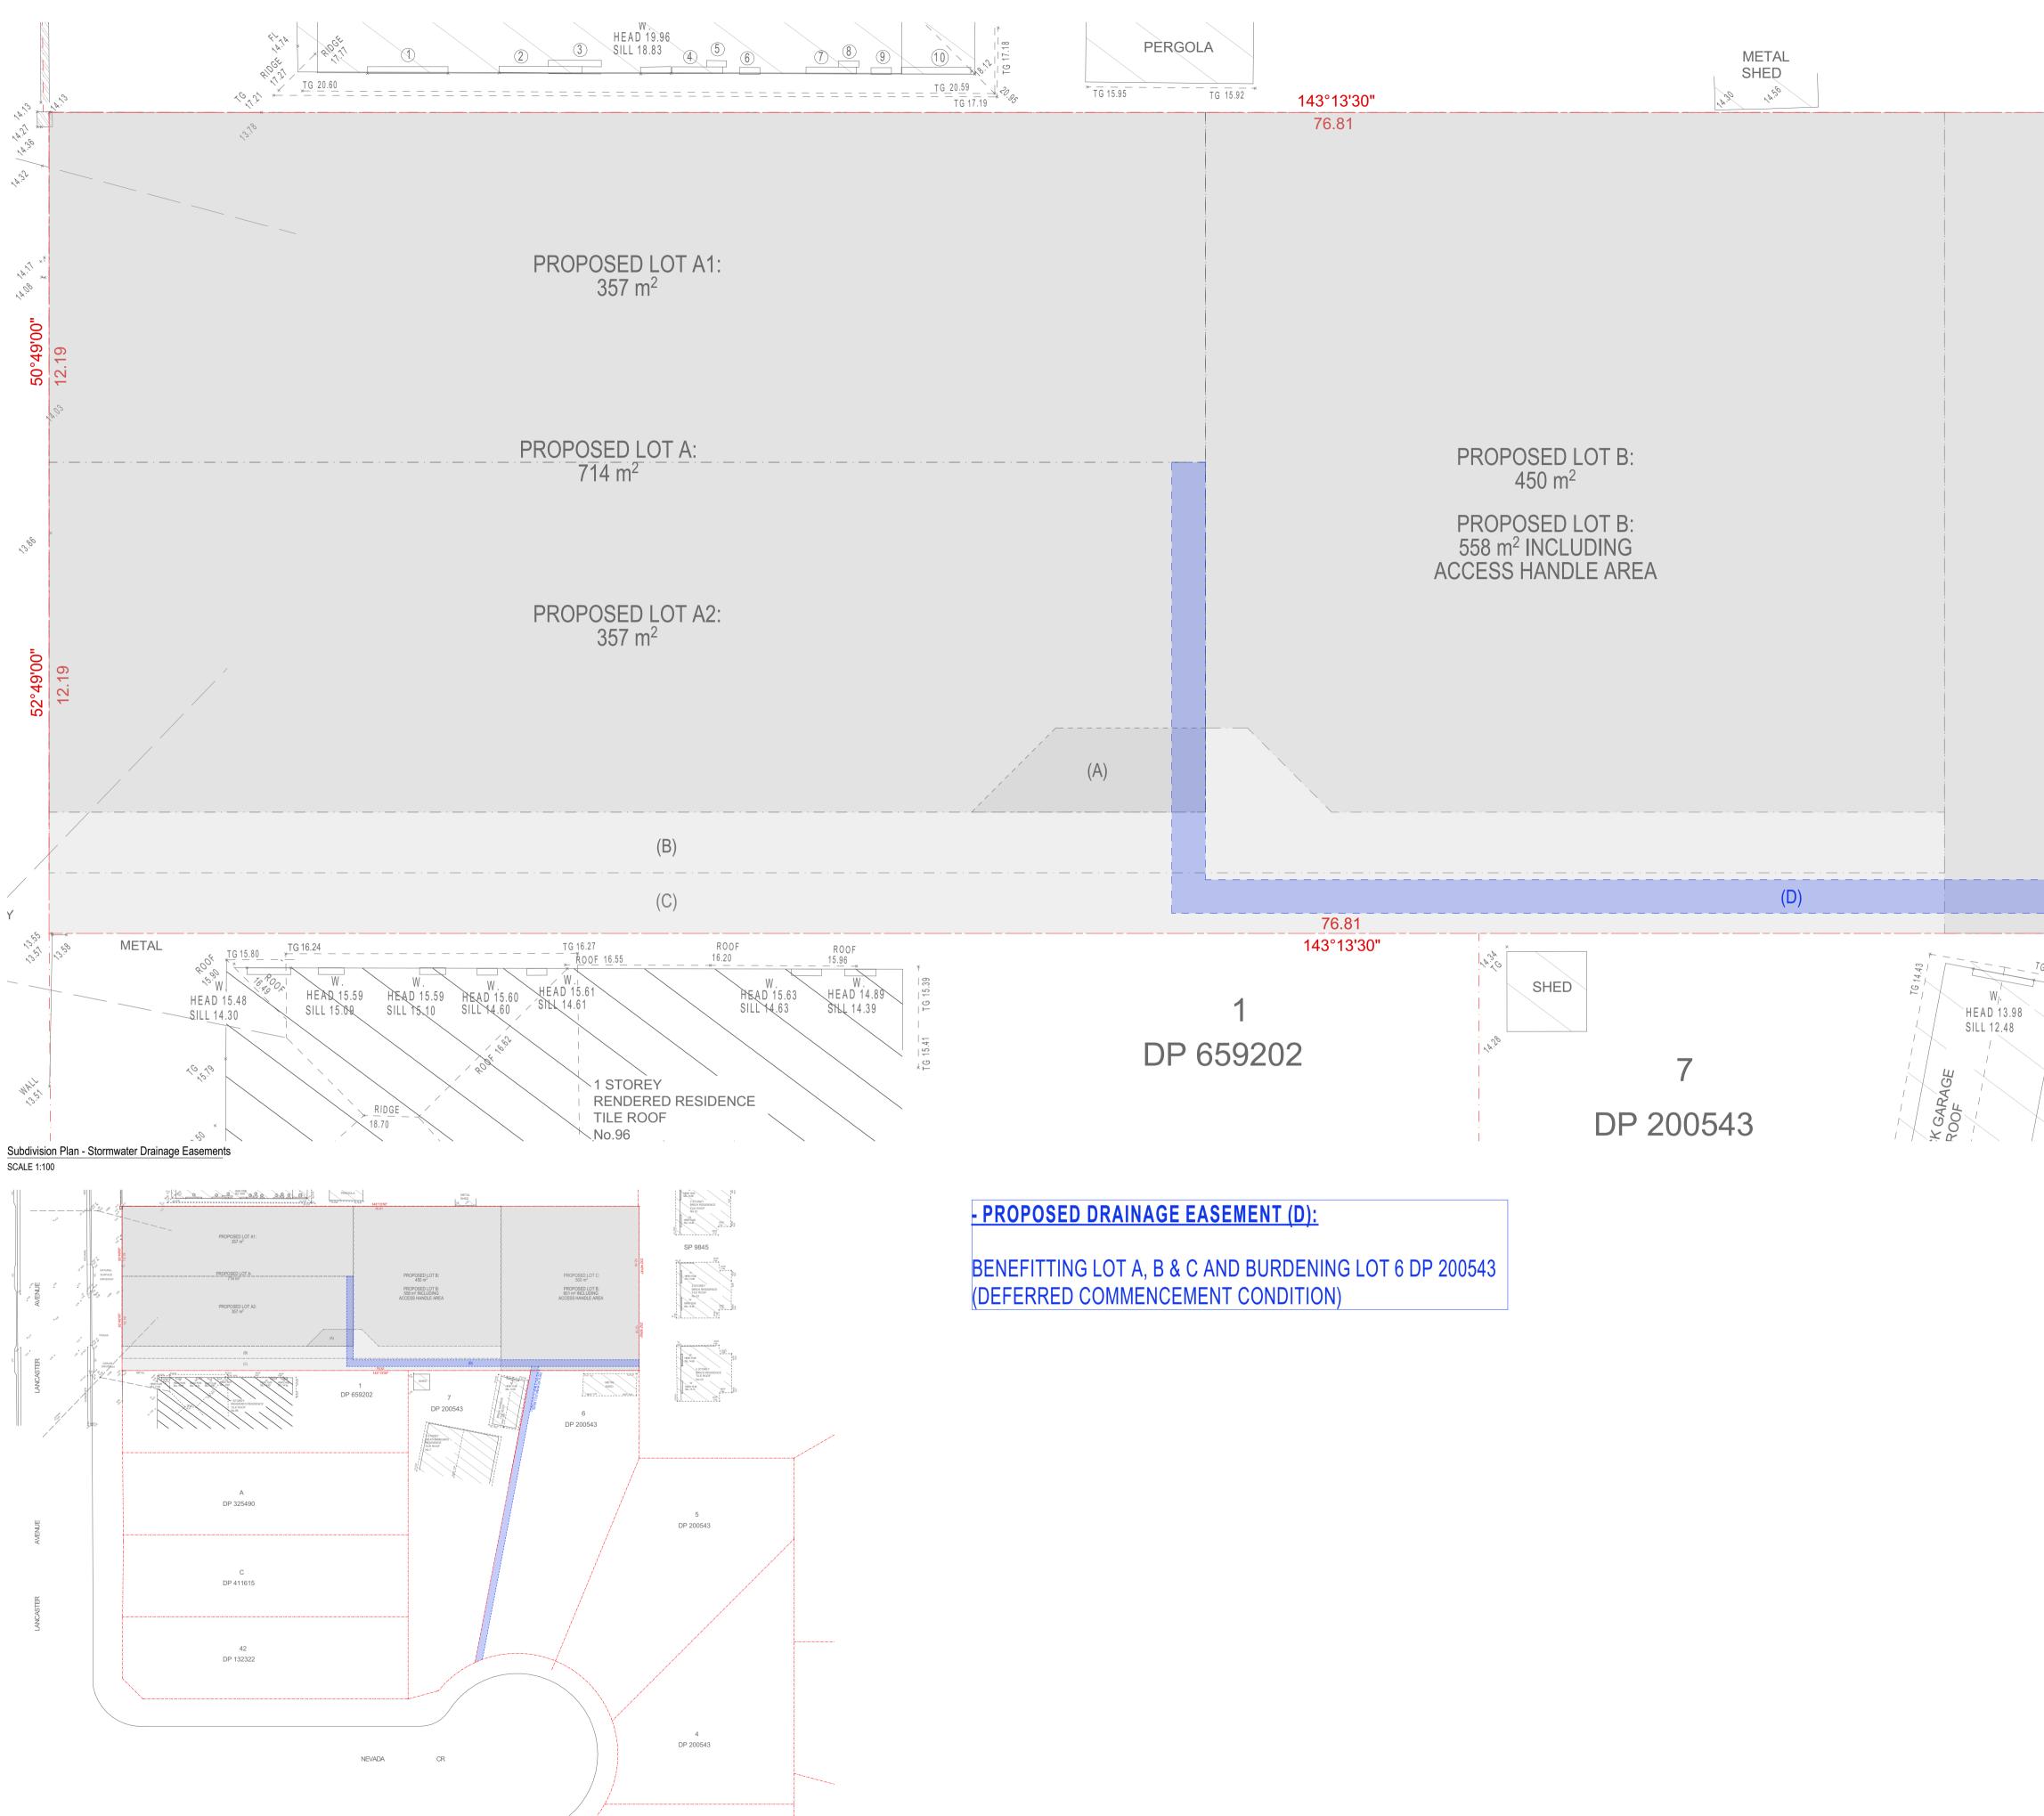
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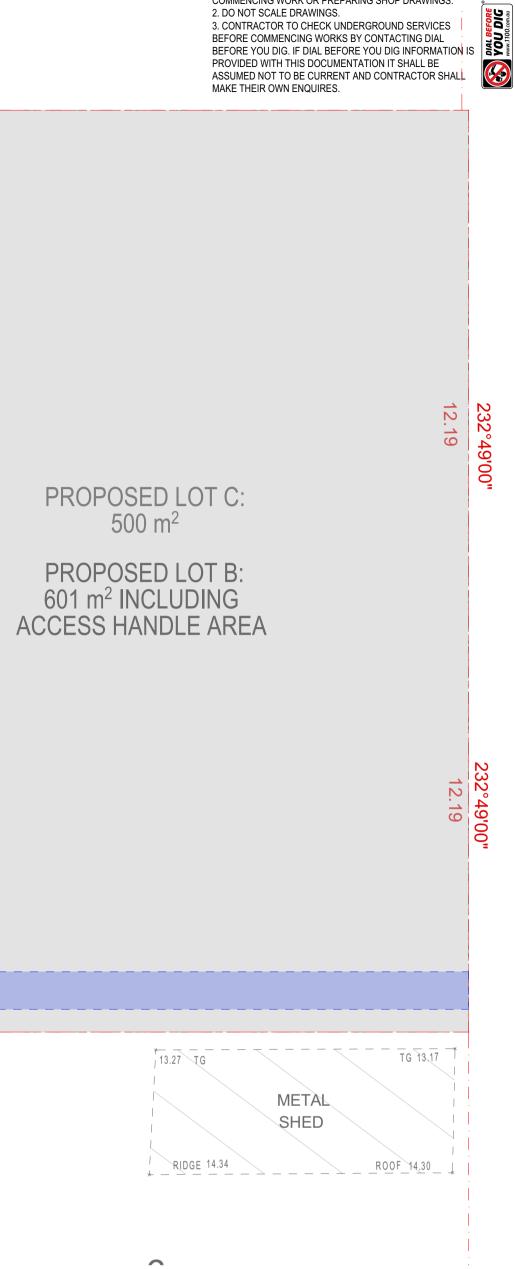
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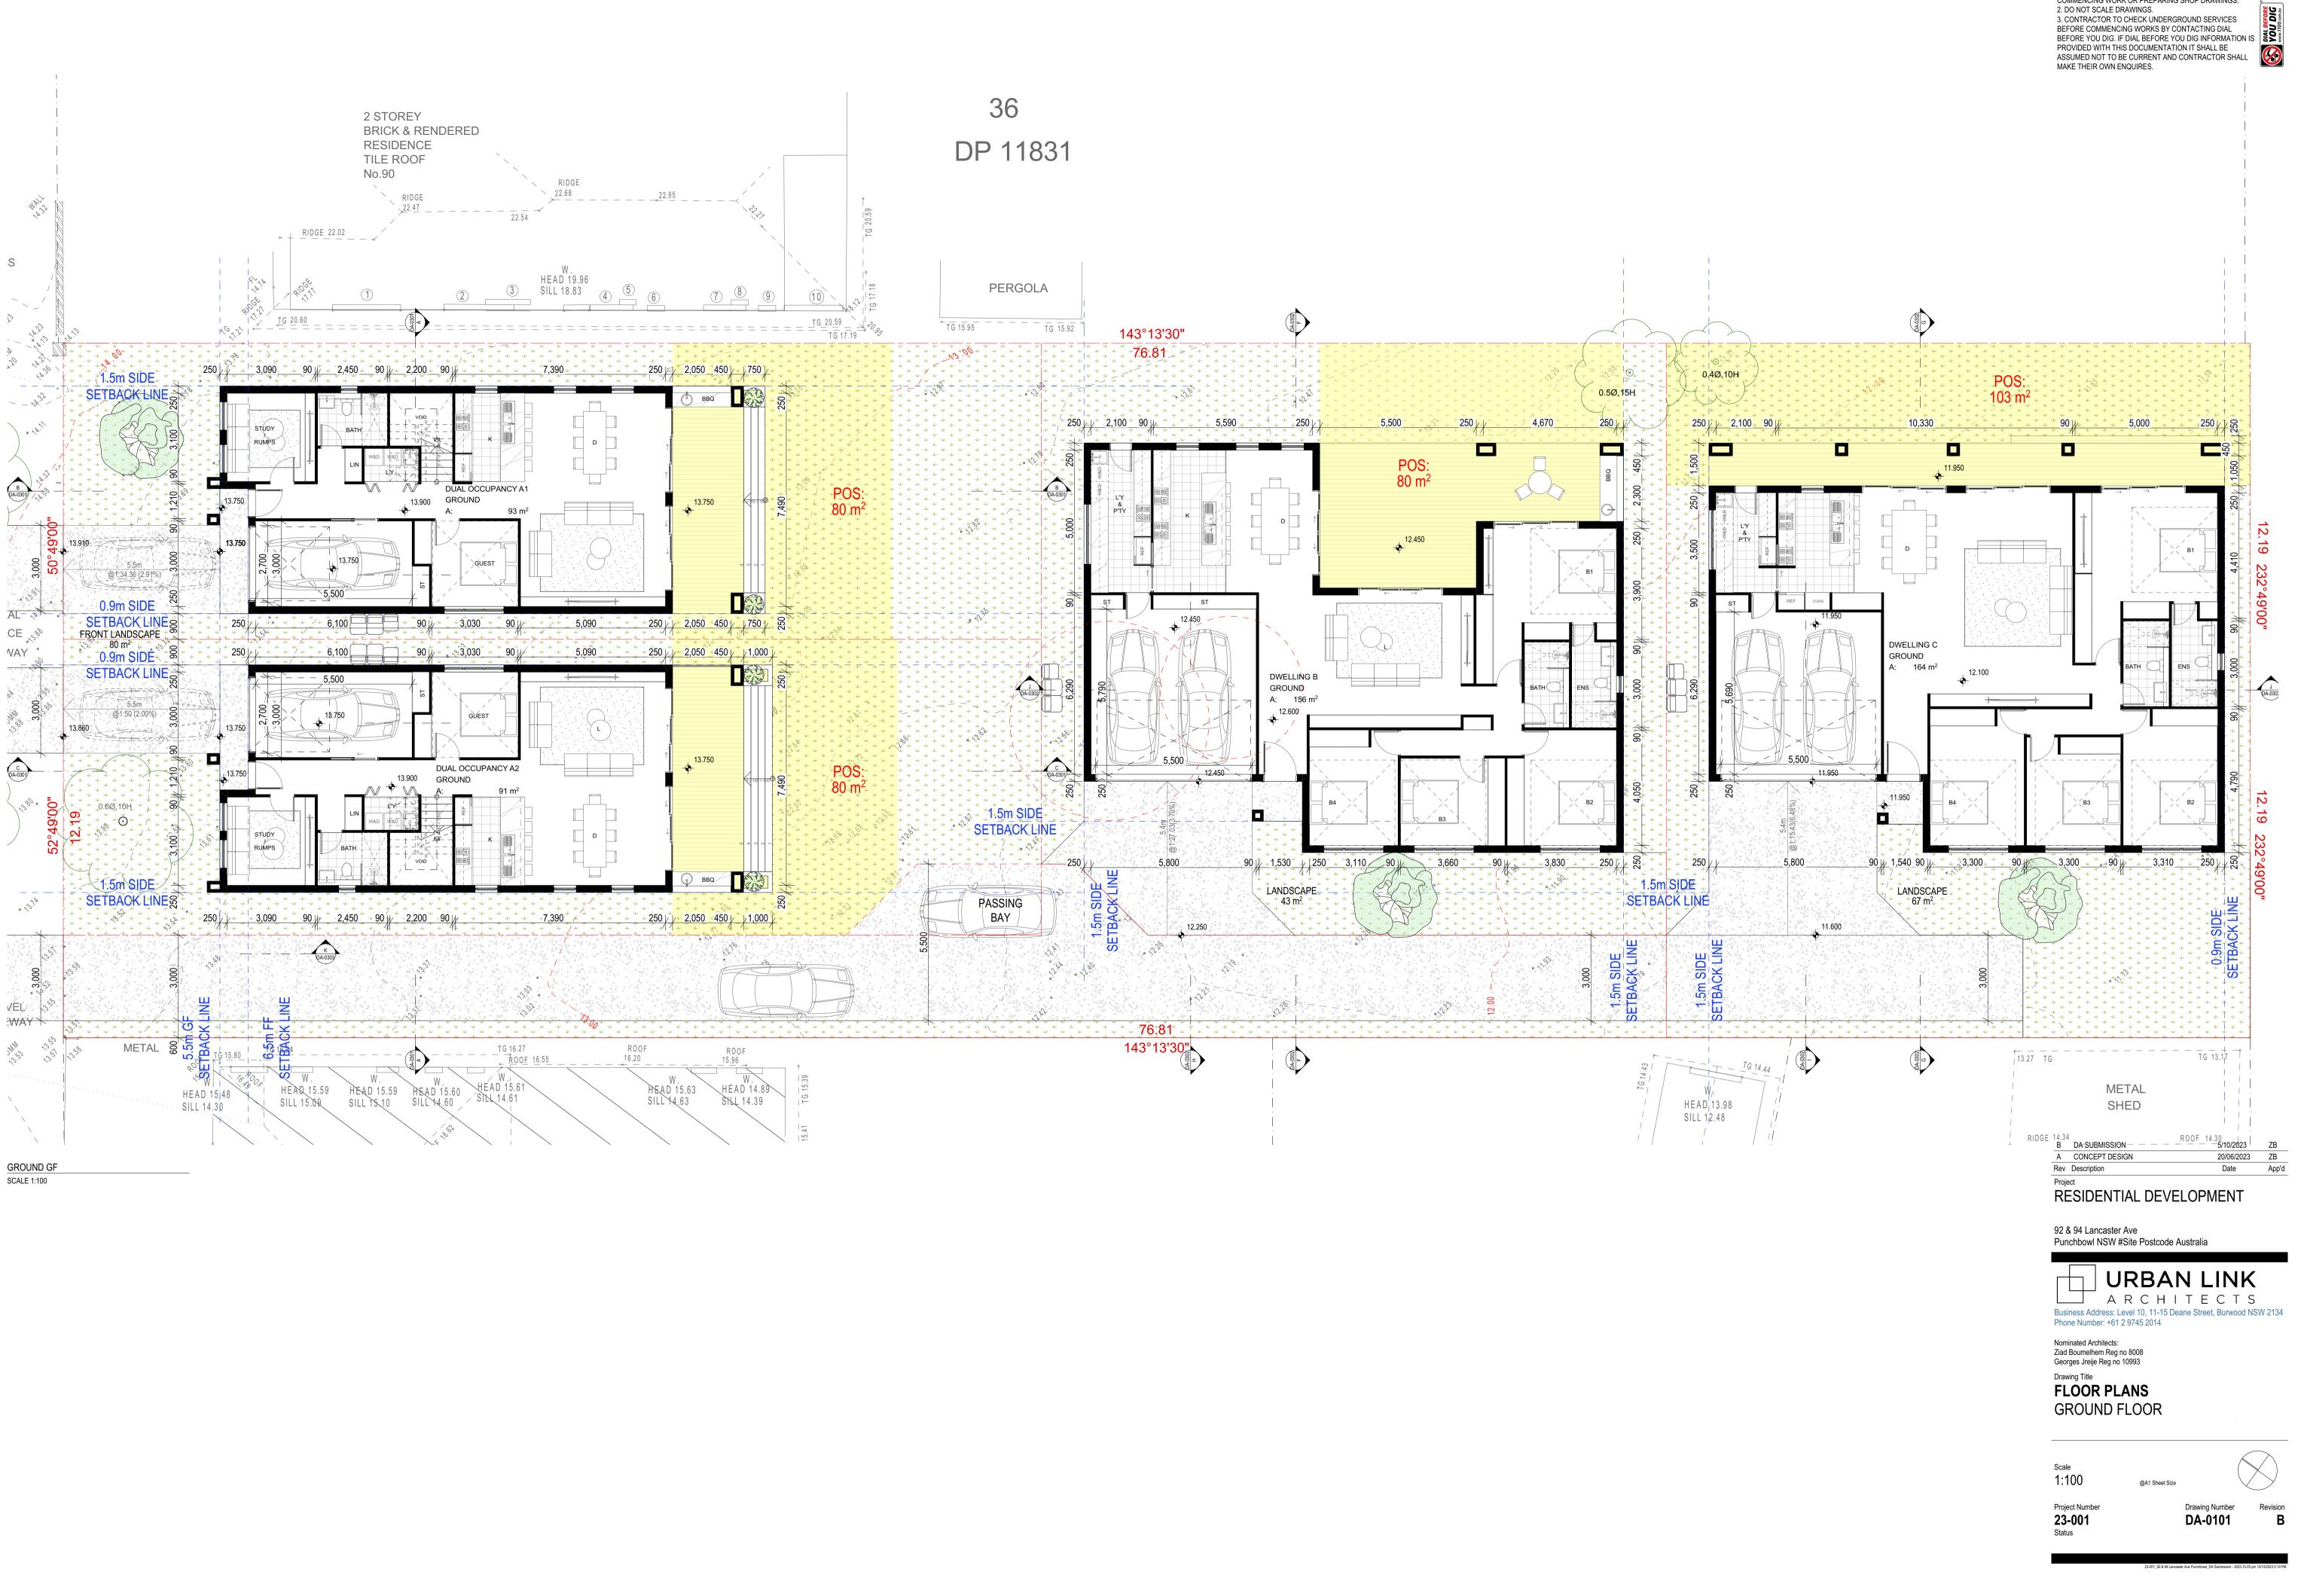


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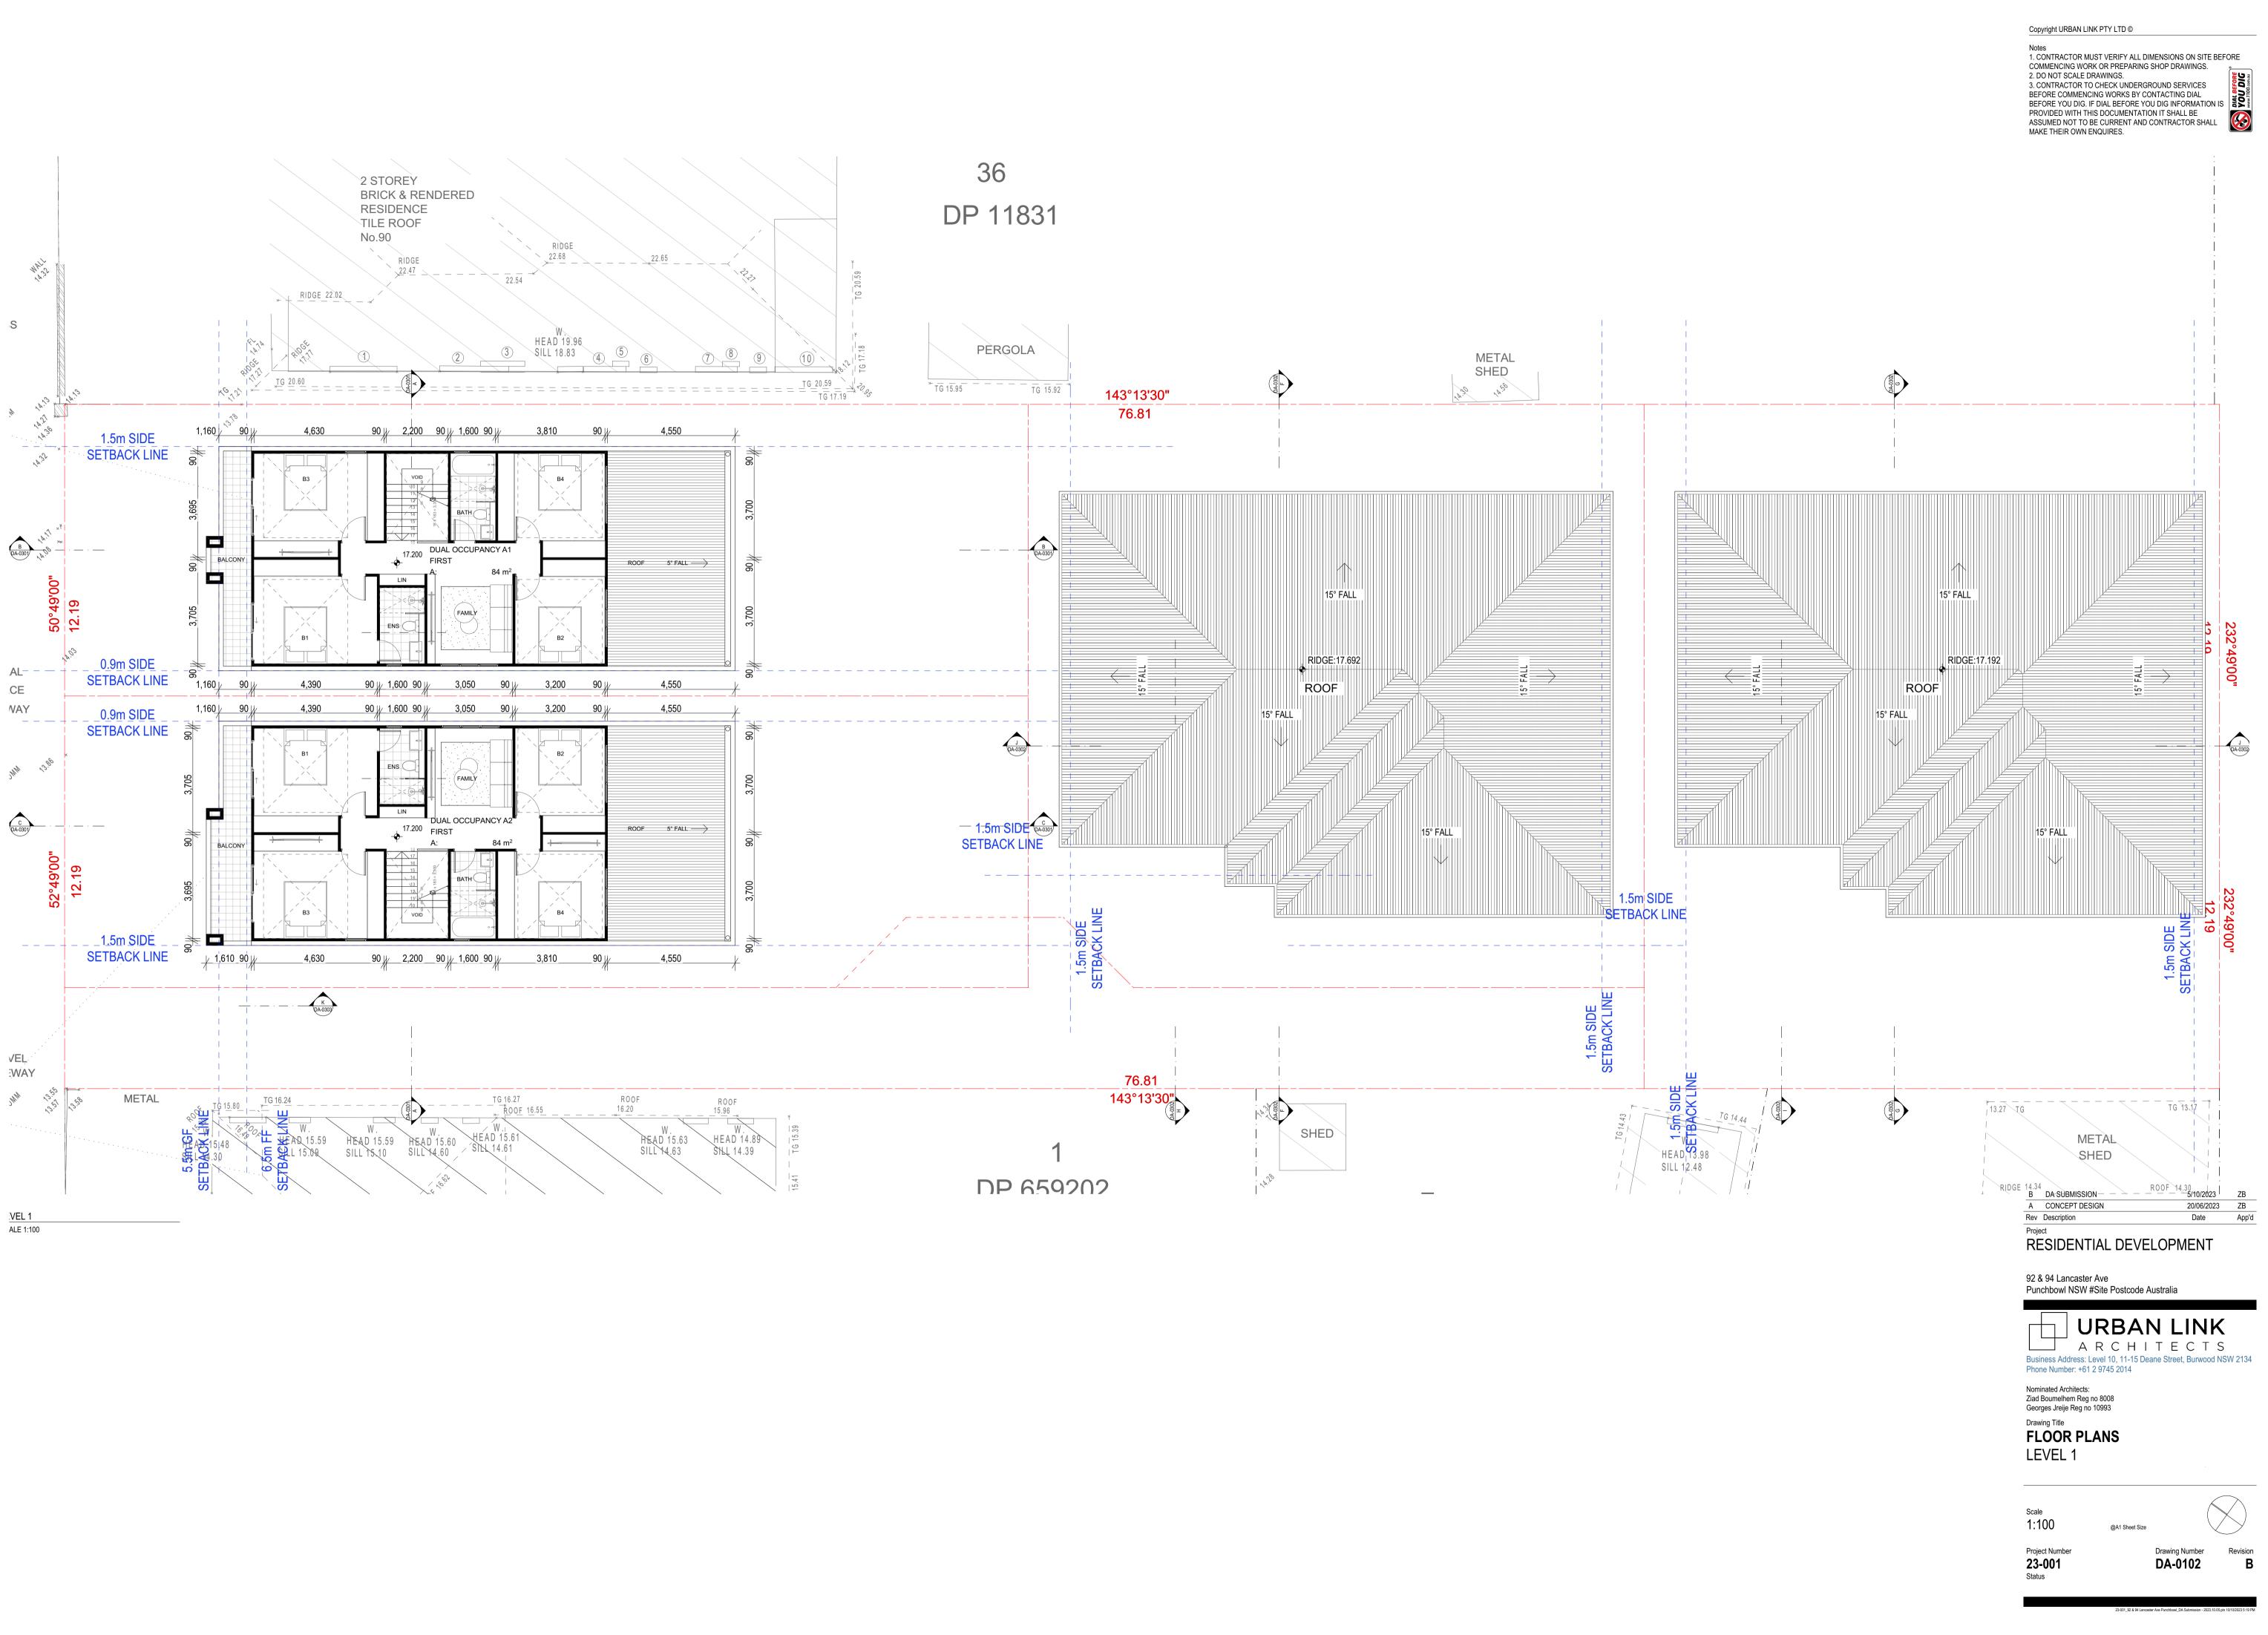





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ROOF SCALE 1:100

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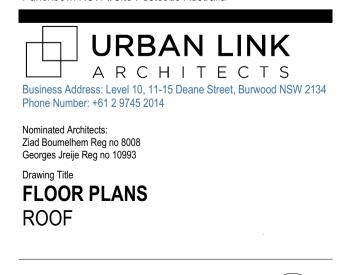
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А	CONCEPT DESIGN	20/06/2023	ZB
Rev	Description	Date	App'd
Proj	ect		
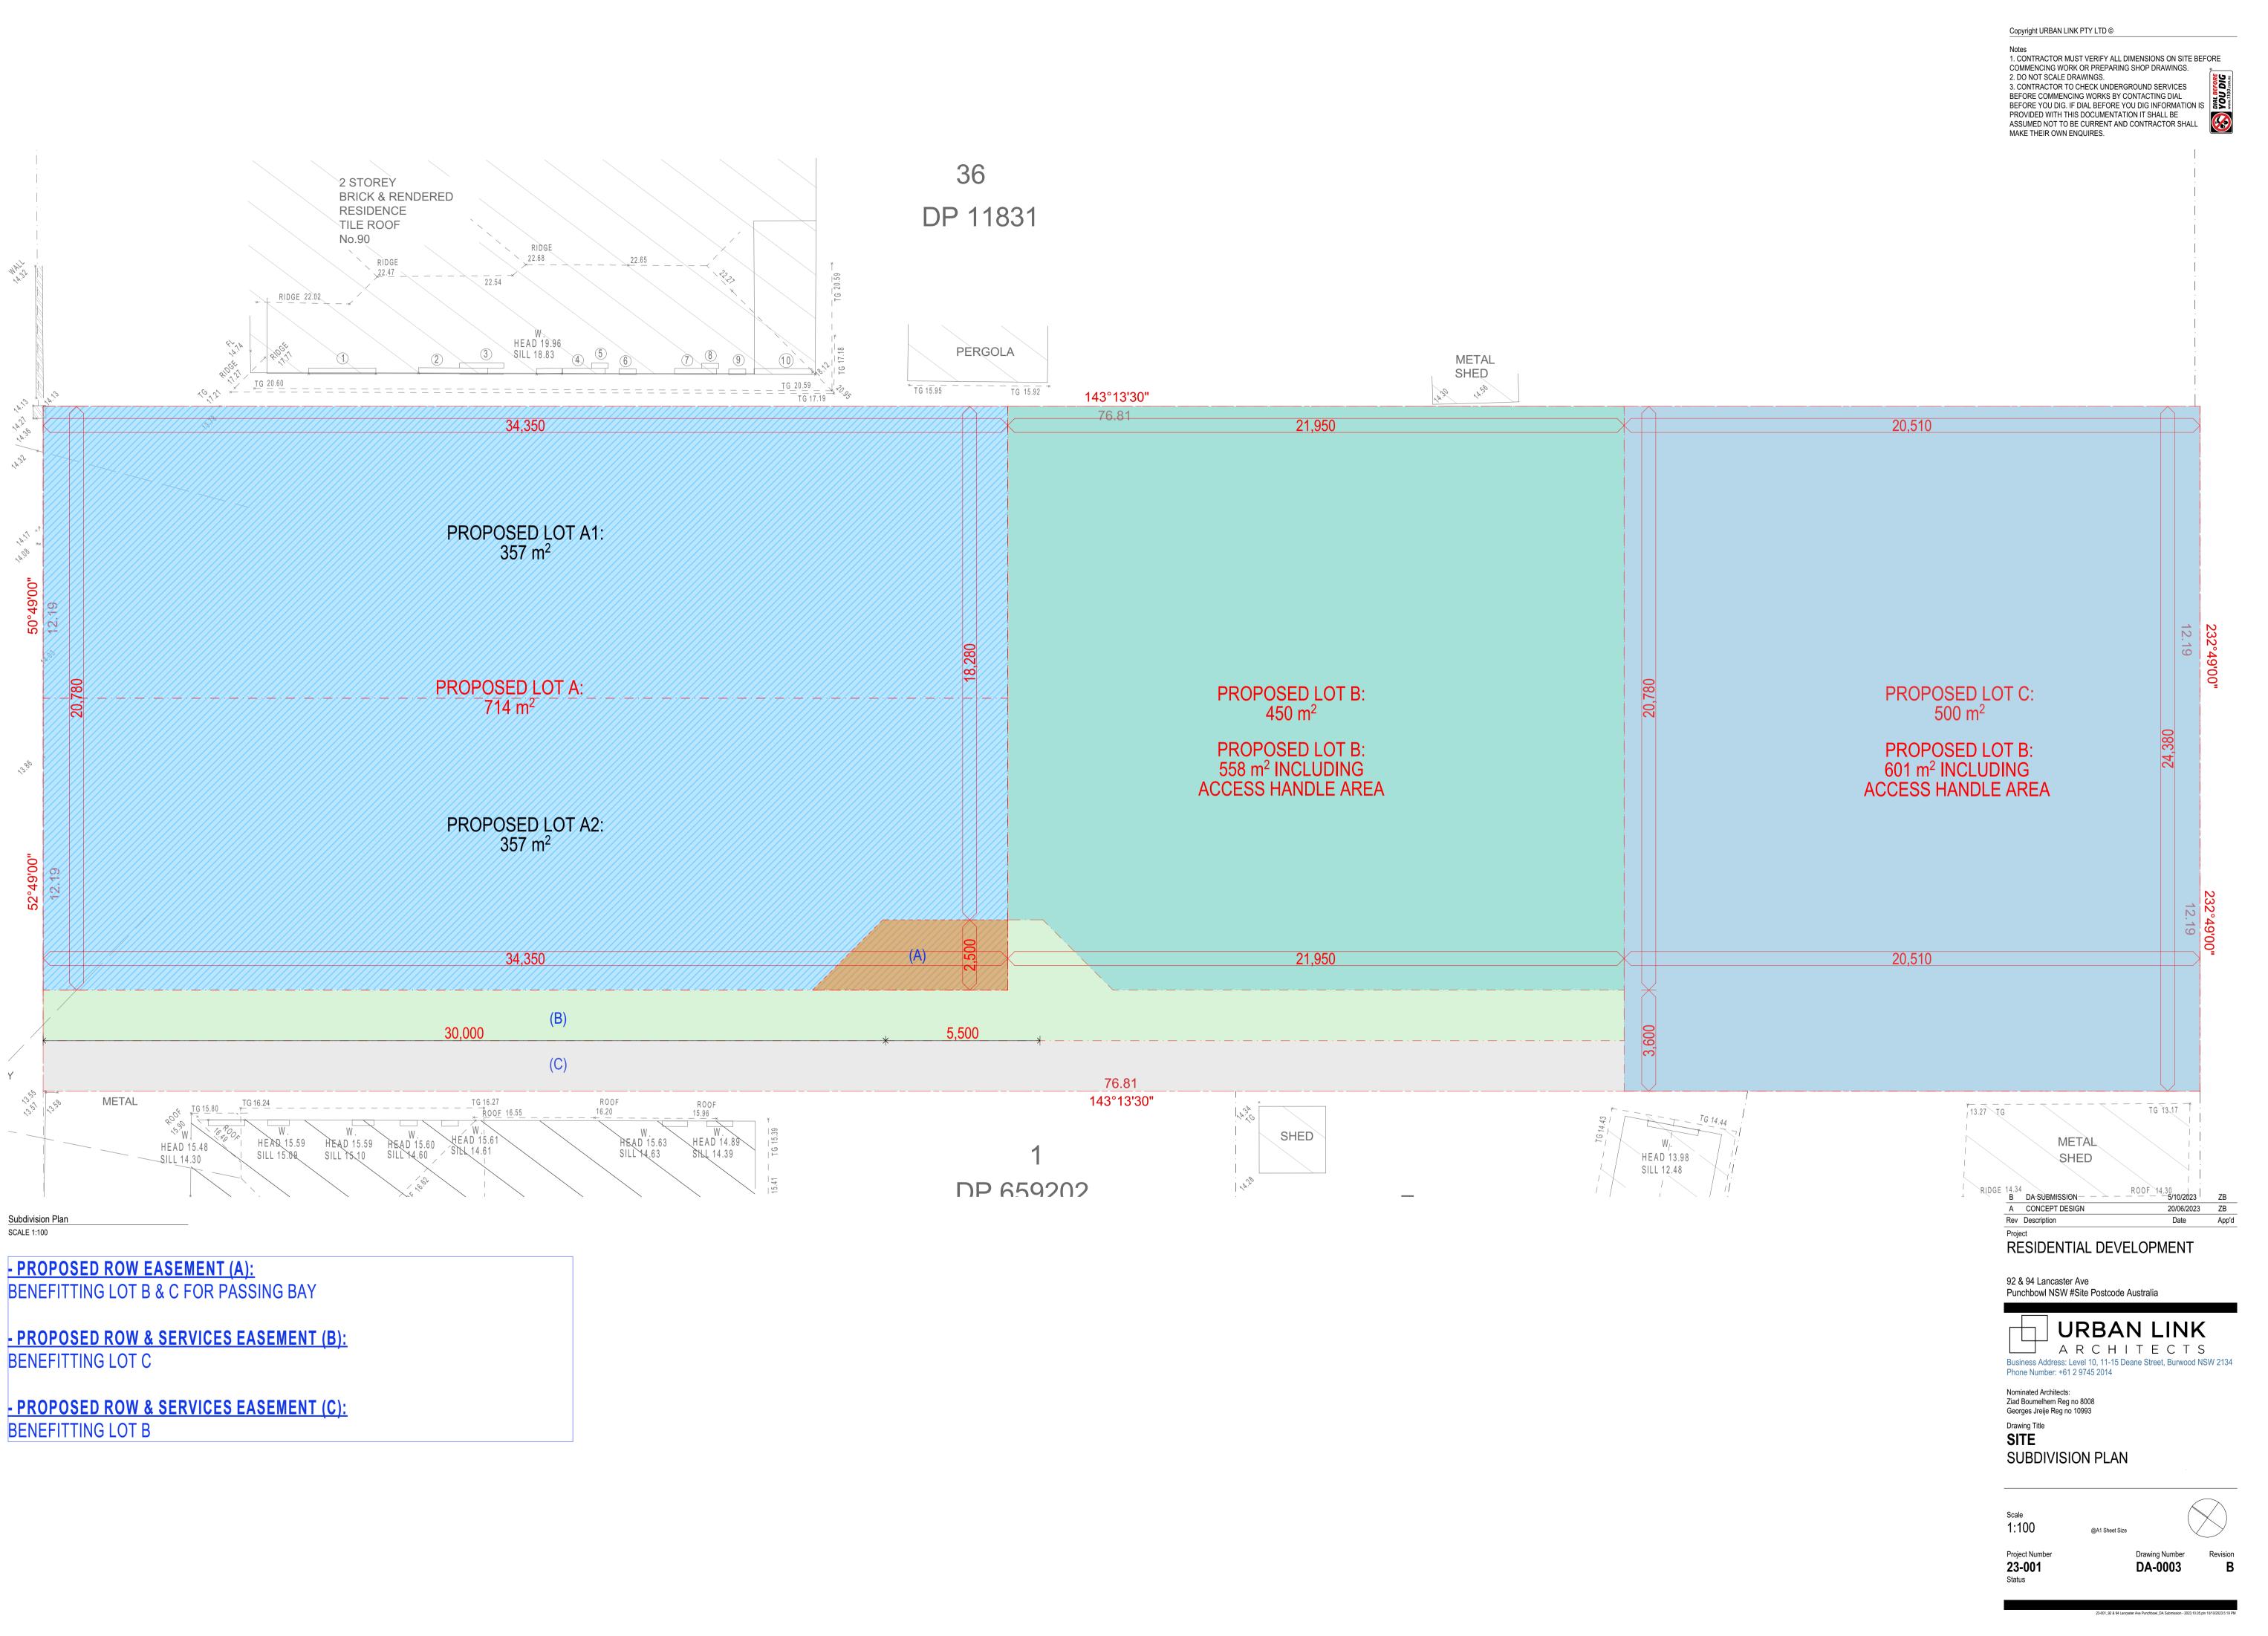
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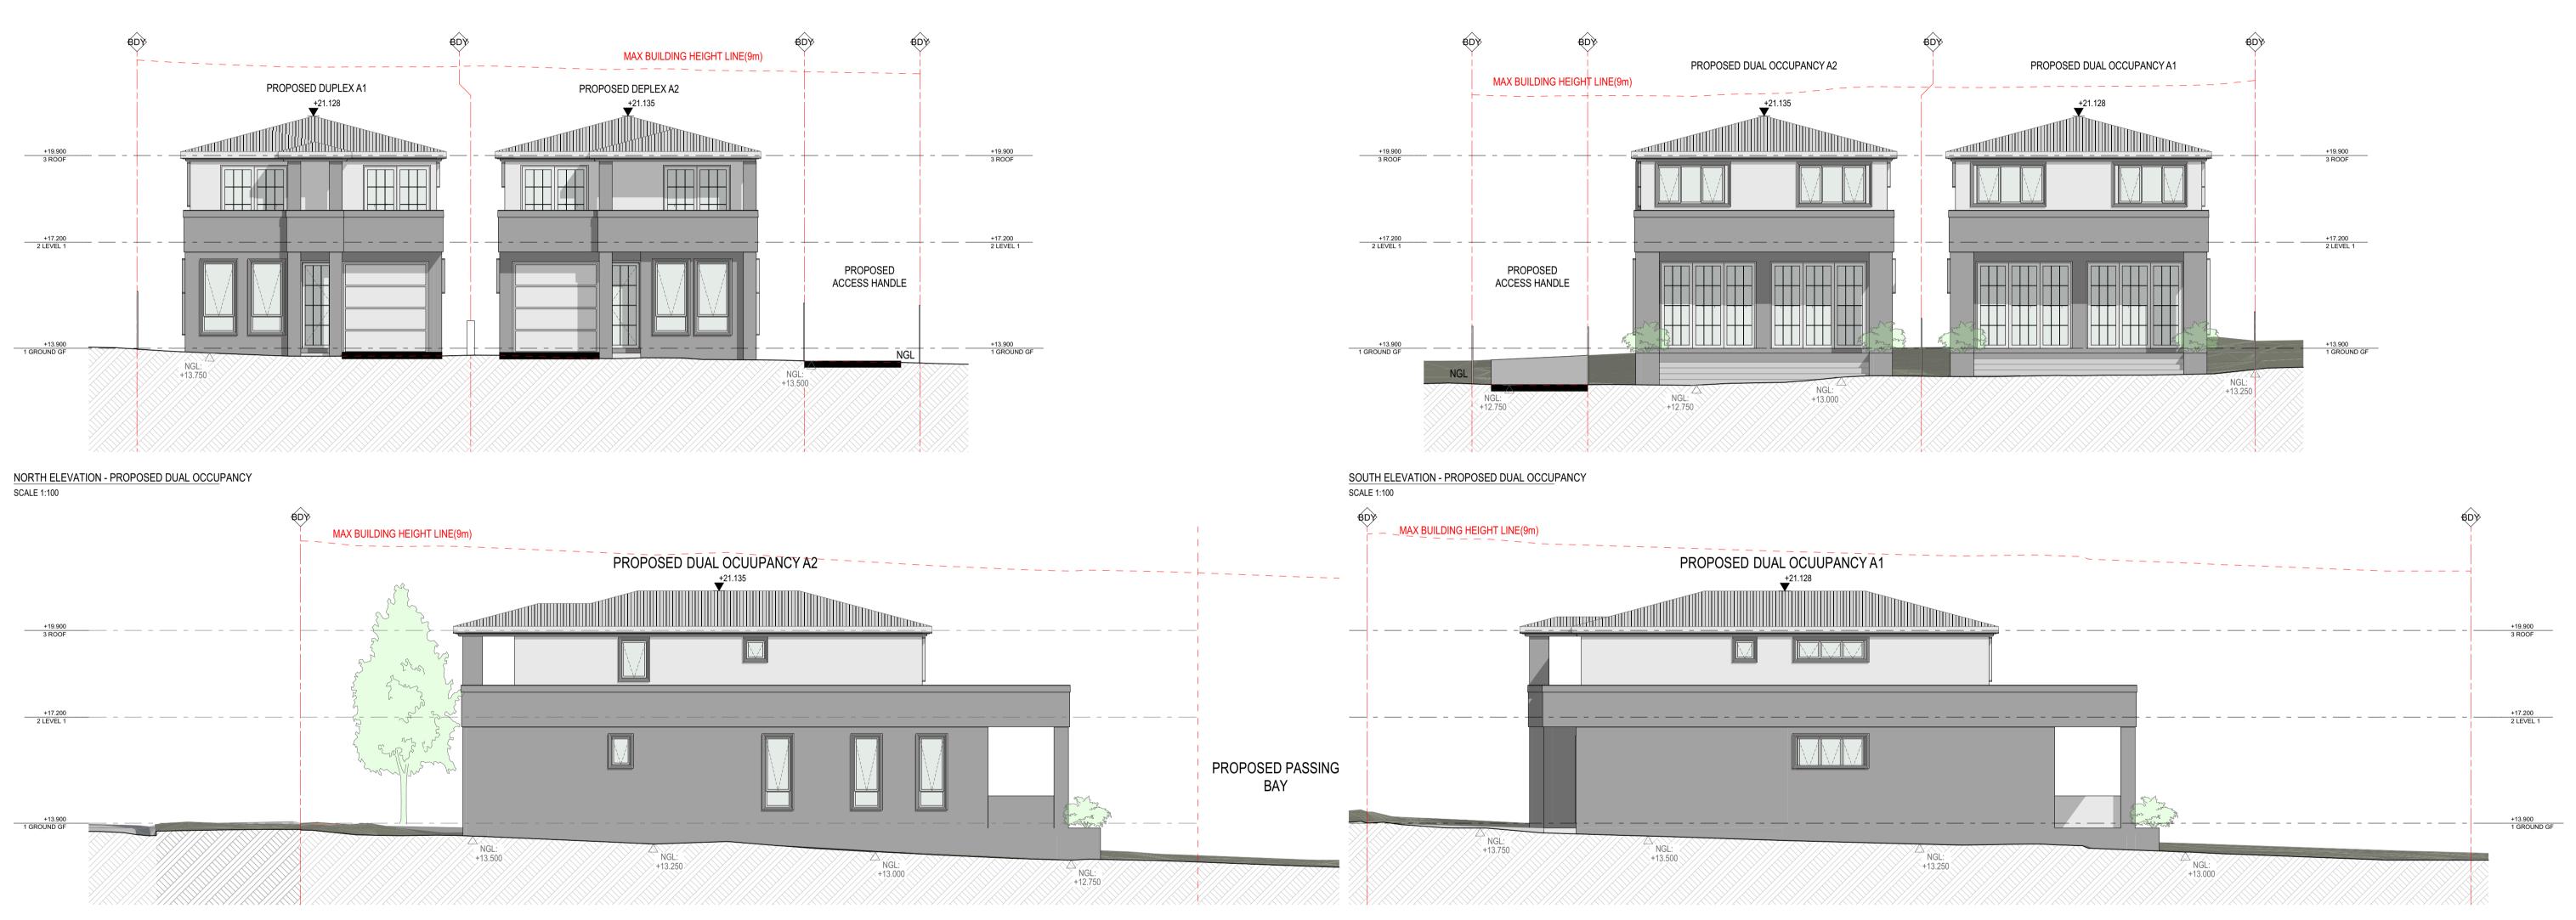
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Revision В

Drawing Number

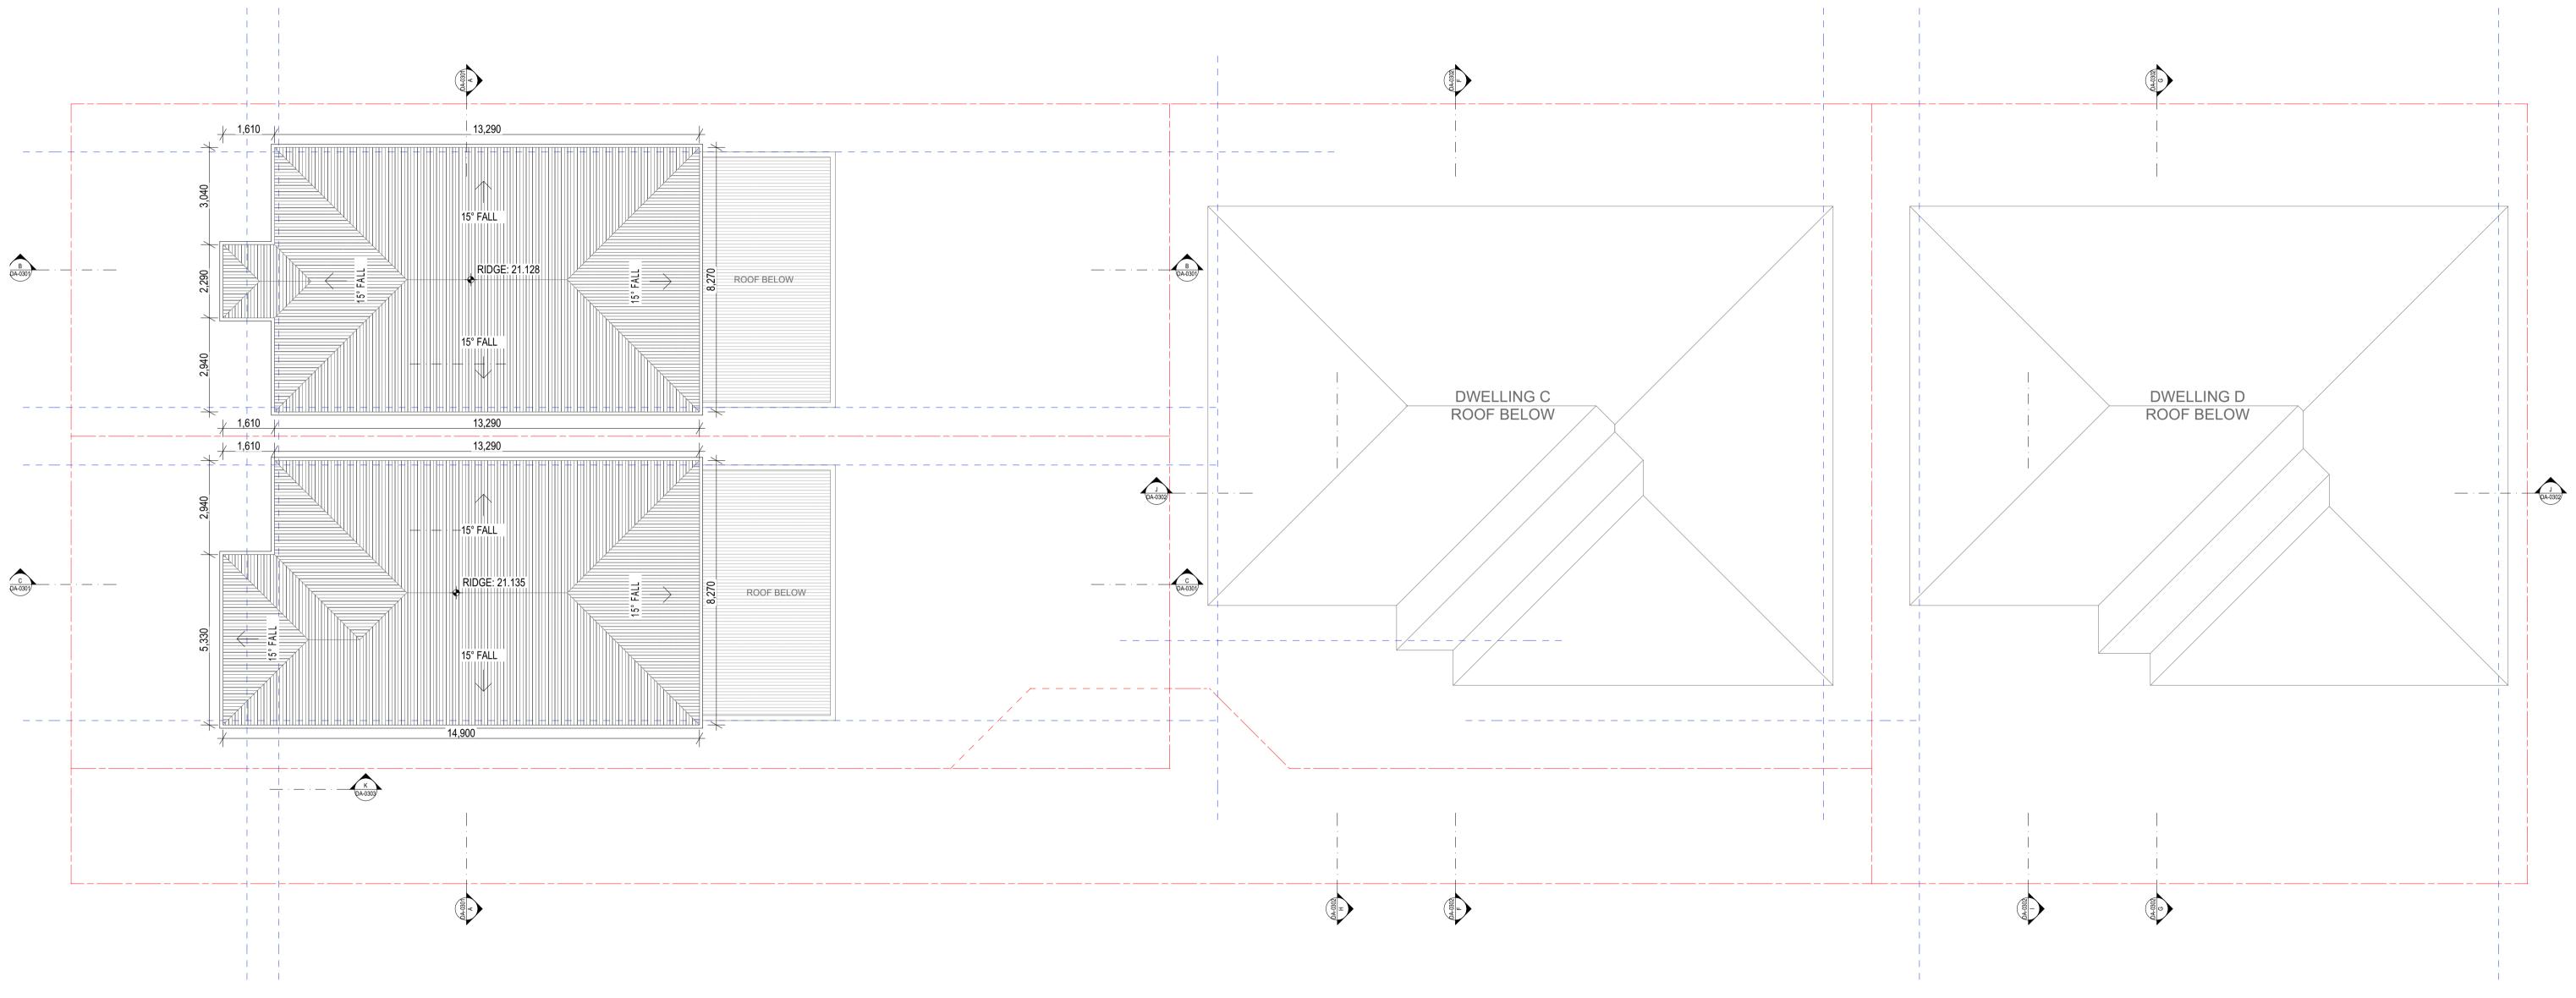DA-0103



WEST ELEVATION SCALE 1:100

WEST ELEVATION - PROPOSED DUAL OCCUPANCY A1 SCALE 1:100

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Nominated Architects: Ziad Boumelhem Reg no 8008 Georges Jreije Reg no 10993


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Scale 1:100


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Drawing Number Revision В


Project Number 23-001 Status



EAST ELEVATION SCALE 1:100

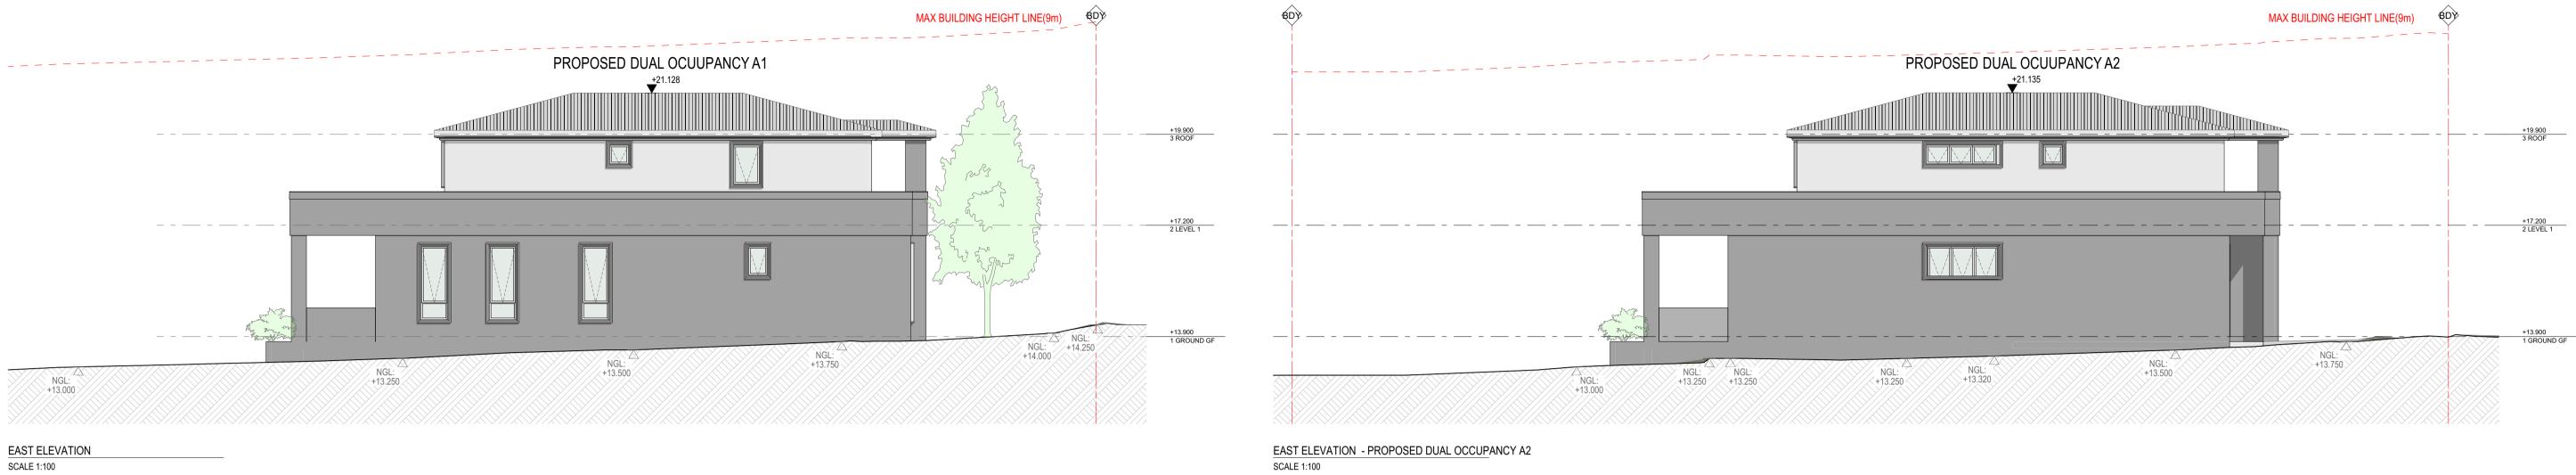

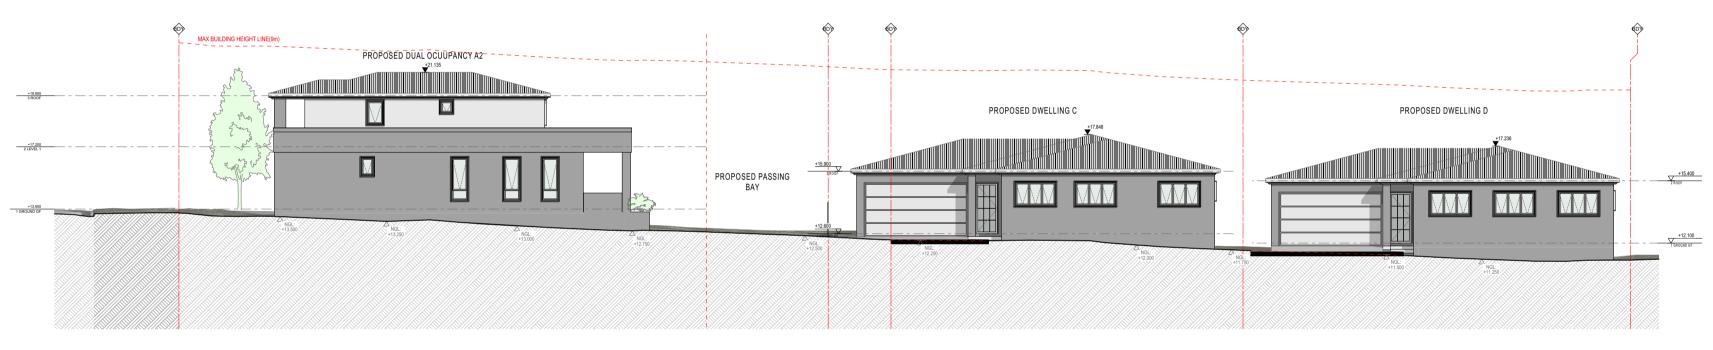WEST ELEVATION SCALE 1:200

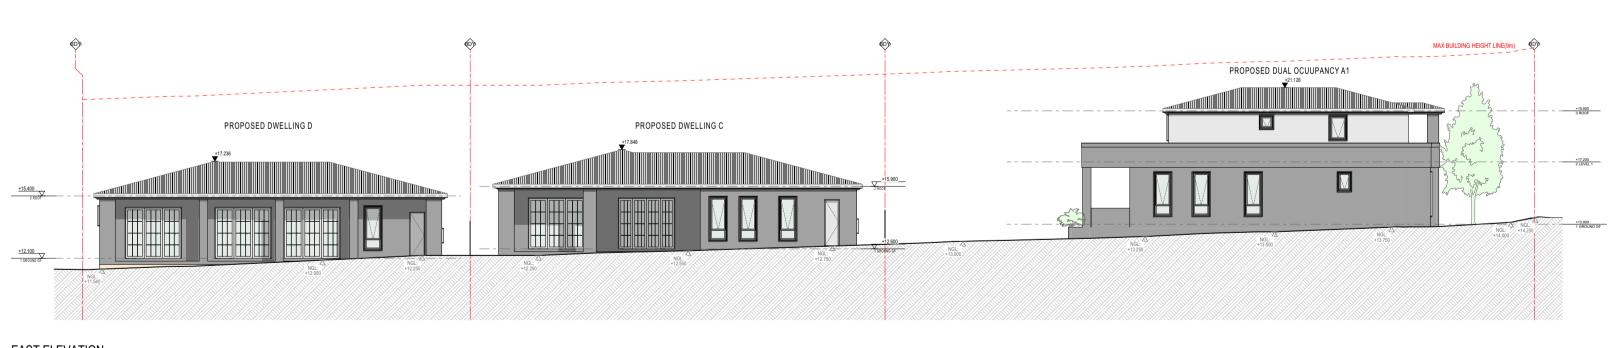

EAST ELEVATION SCALE 1:200

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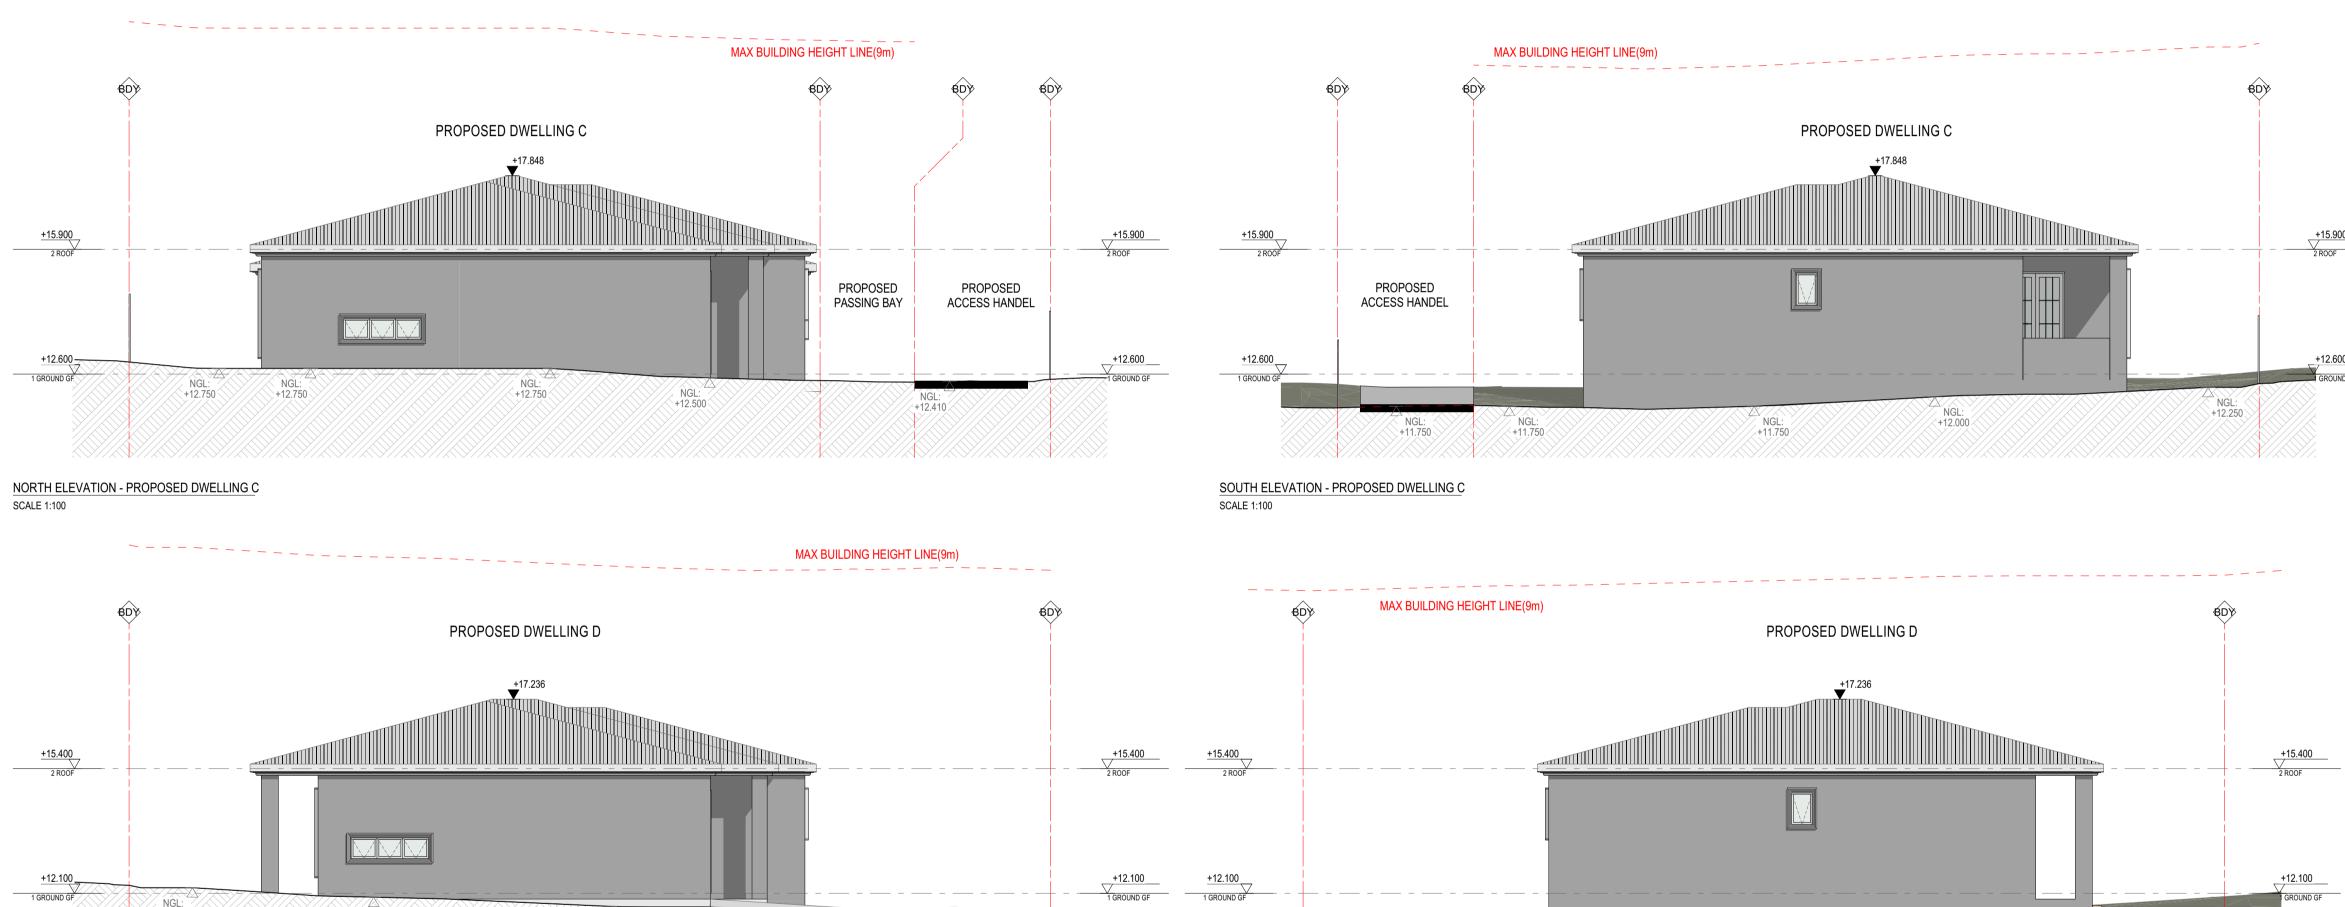
RESIDENTIAL DEVELOPMENT


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NORTH ELEVATION - PROPOSED DWELLING D

SCALE 1:100

SOUTH ELEVATION - PROPOSED DWELLING D

SCALE 1:100

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+15.900

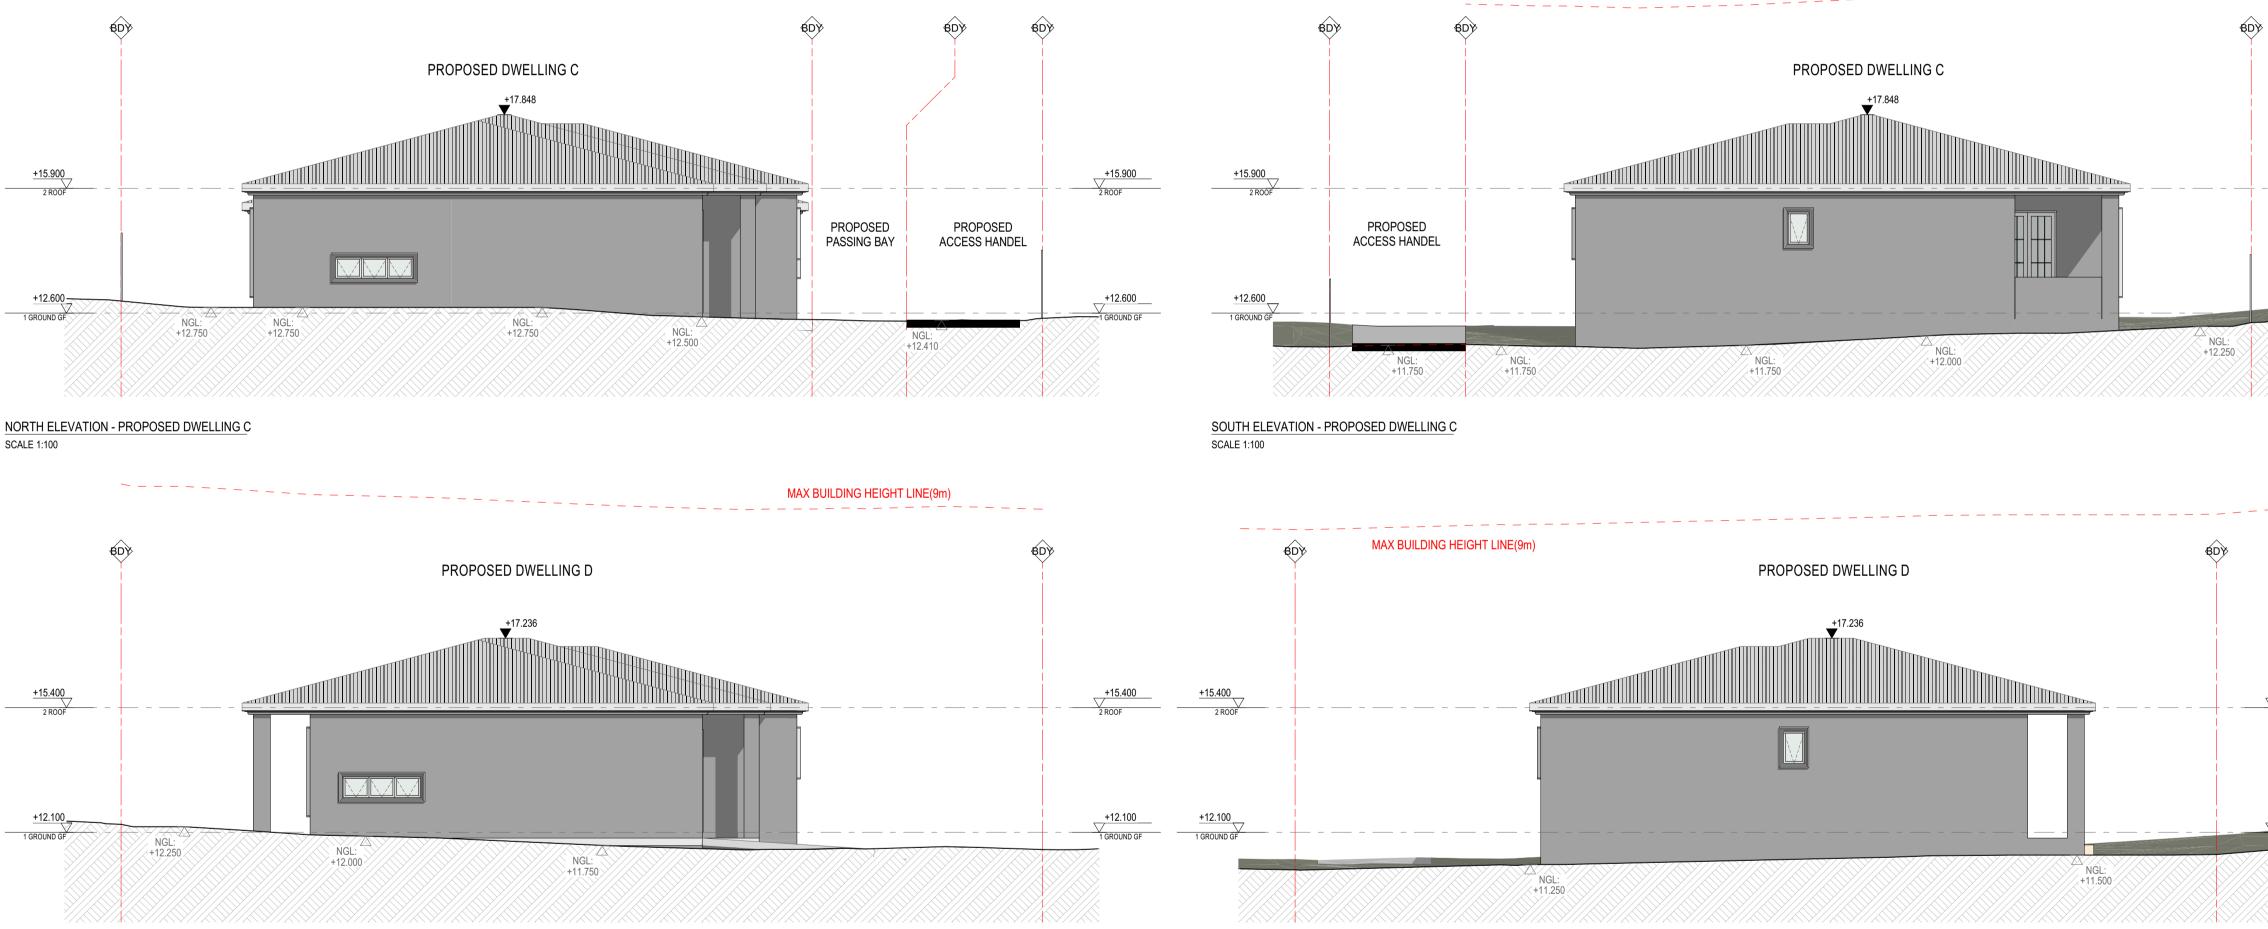_+12.600 ____

GROUND GF

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Drawing Title ELEVATIONS **ELEVATIONS 03 - DWELLINGS**

@A1 Sheet Size

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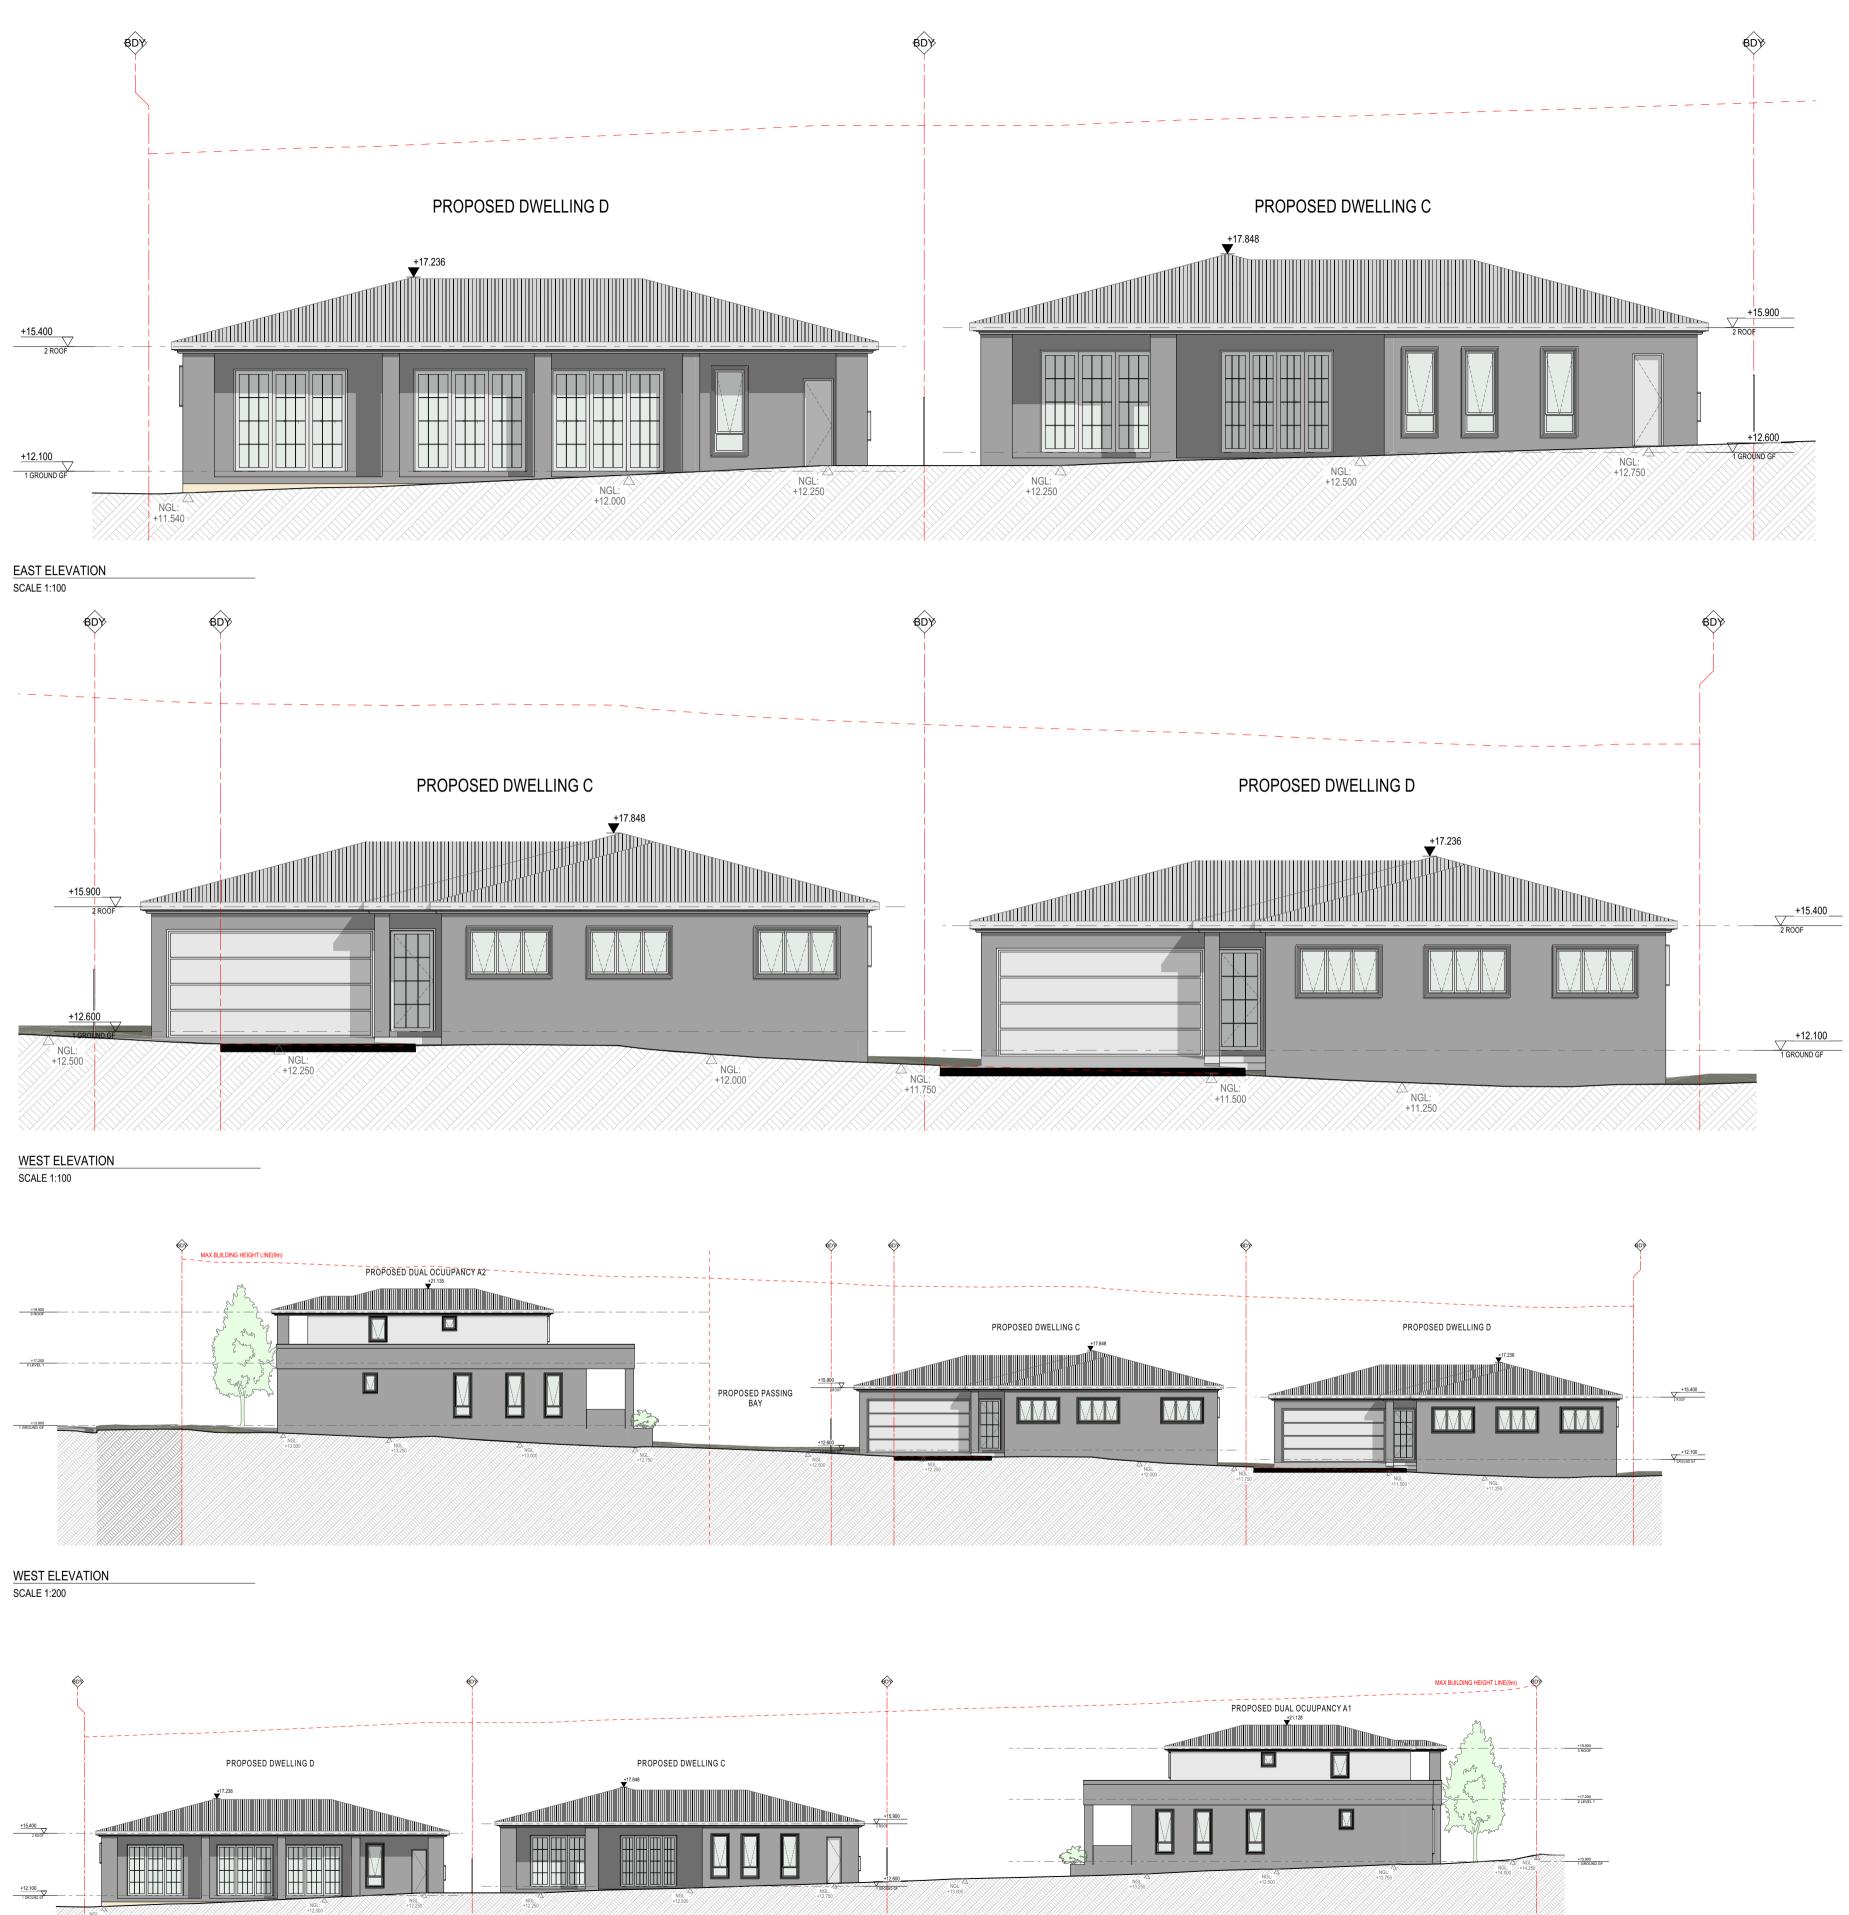
23-001

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Drawing Number

Revision DA-0203 В









EAST ELEVATION SCALE 1:200

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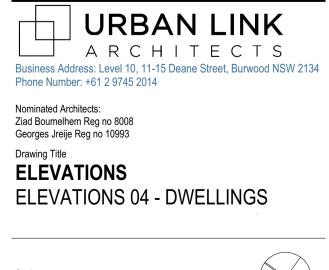
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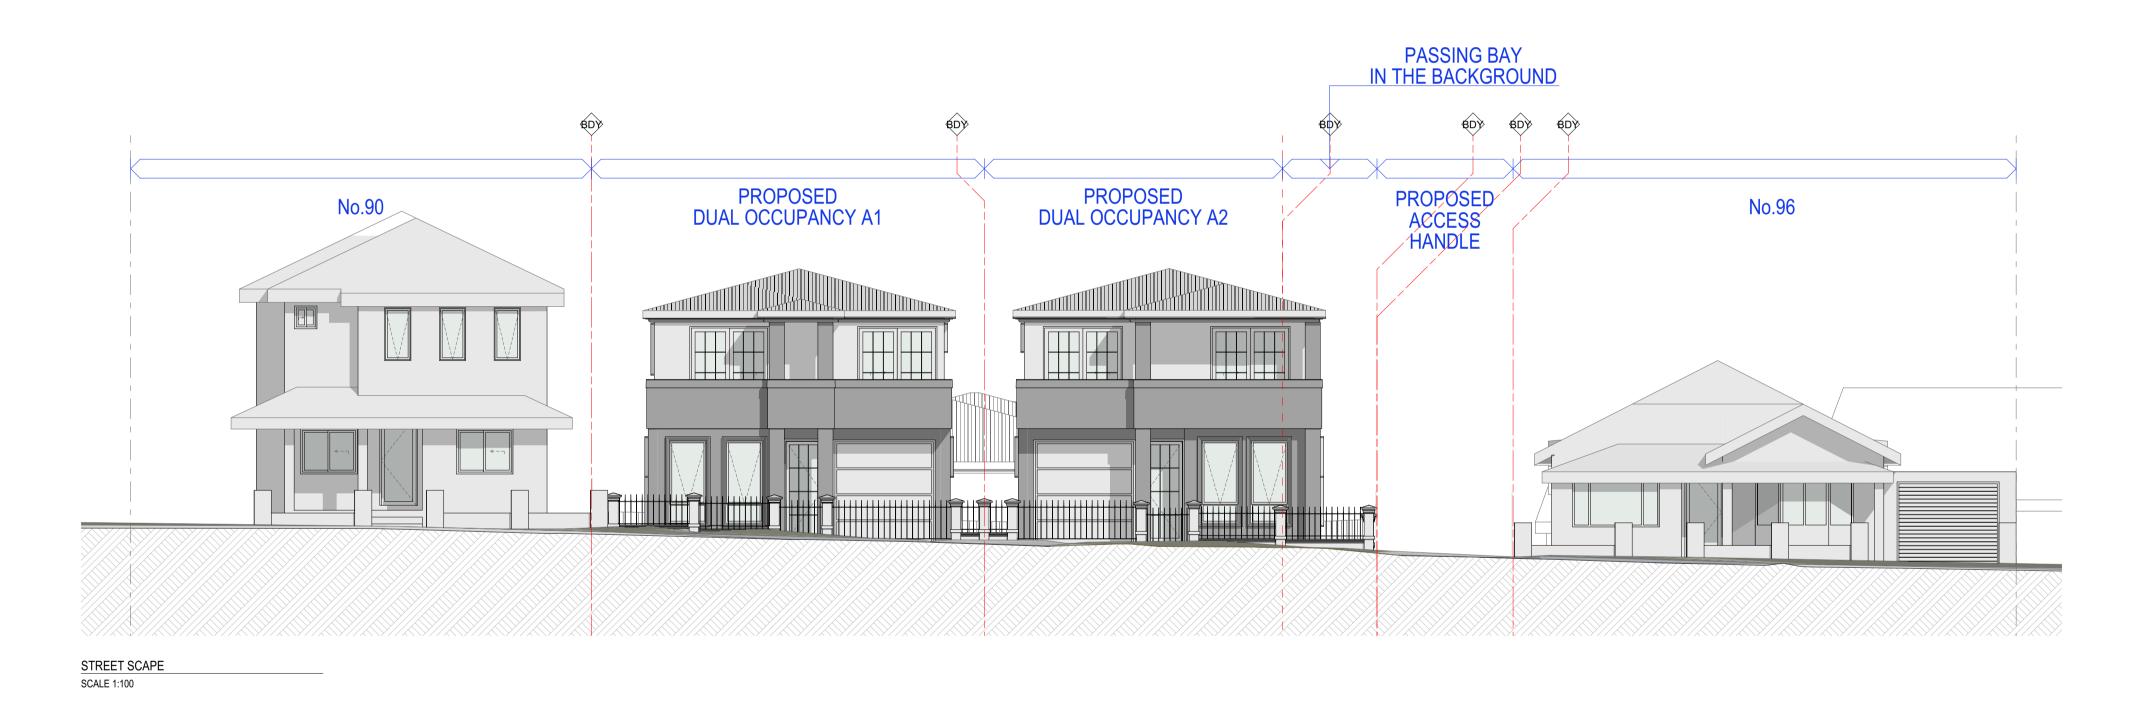
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Scale 1:100, 1:200 @A1 Sheet Size







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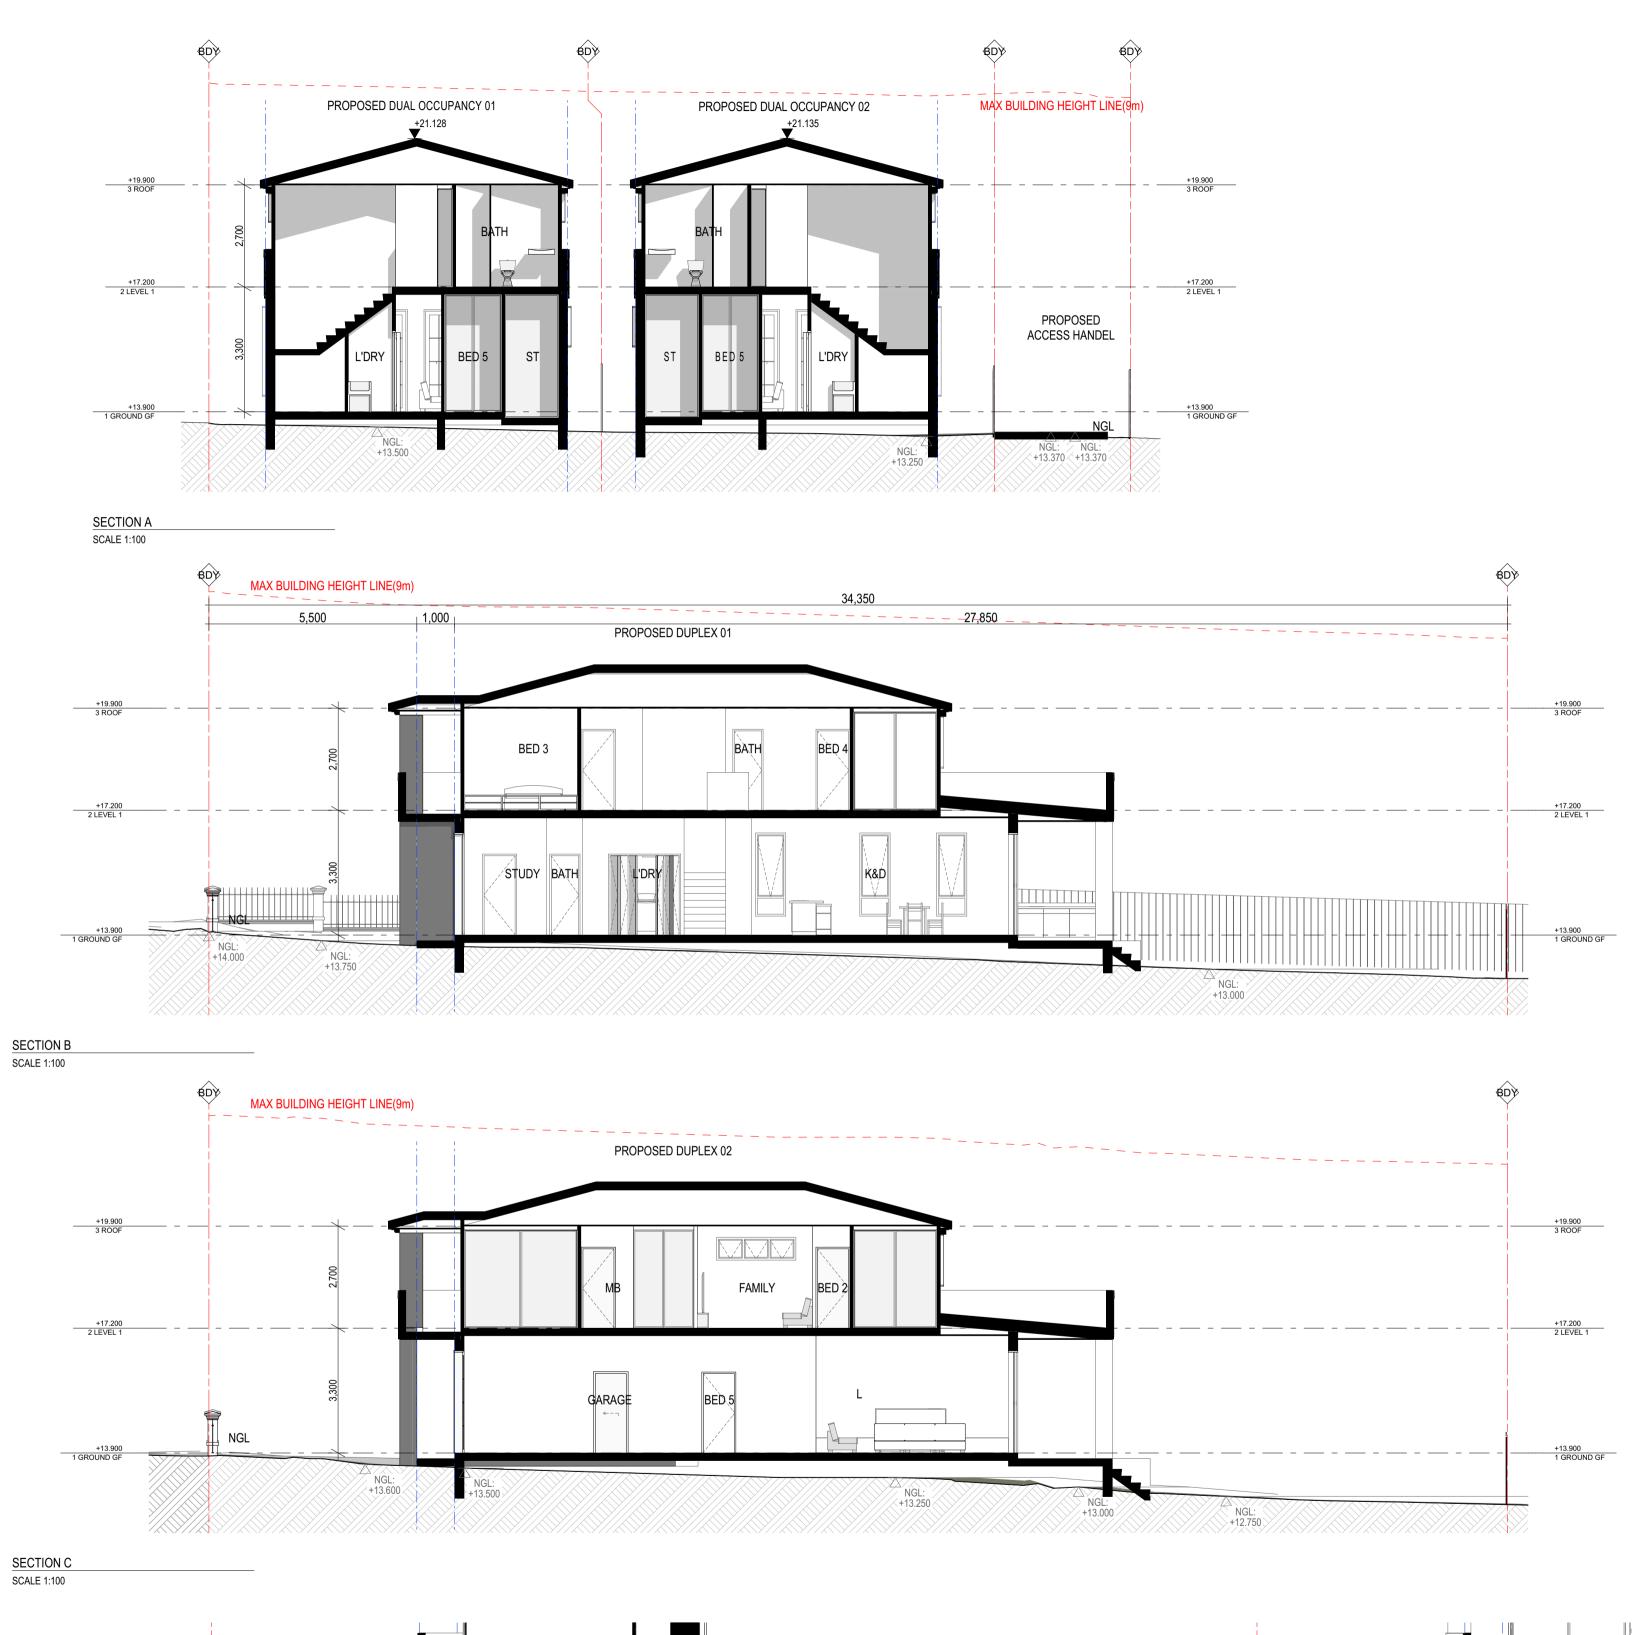


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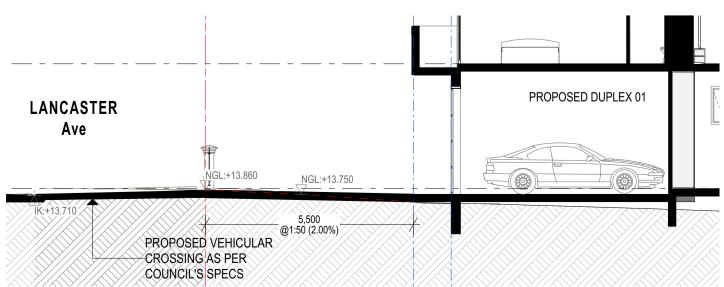
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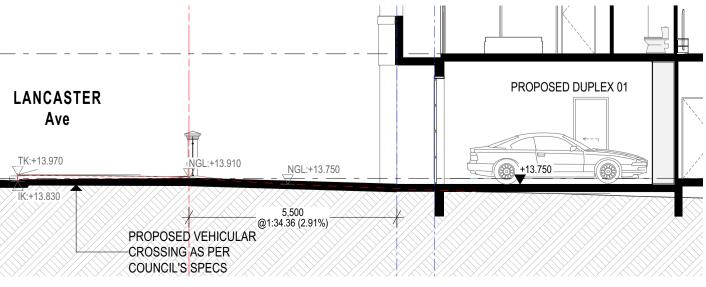
Drawing Number Revision **DA-0205 B**



SECTION C SCALE 1:100



×IK:+13.830



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MAKE THEIR OWN ENQUIRES.

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Project RESIDENTIAL DEVELOPMENT

92 & 94 Lancaster Ave Punchbowl NSW #Site Postcode Australia



Nominated Architects: Ziad Boumelhem Reg no 8008 Georges Jreije Reg no 10993

Drawing Title SECTIONS

SECTIONS - DUAL OCCUPANCY


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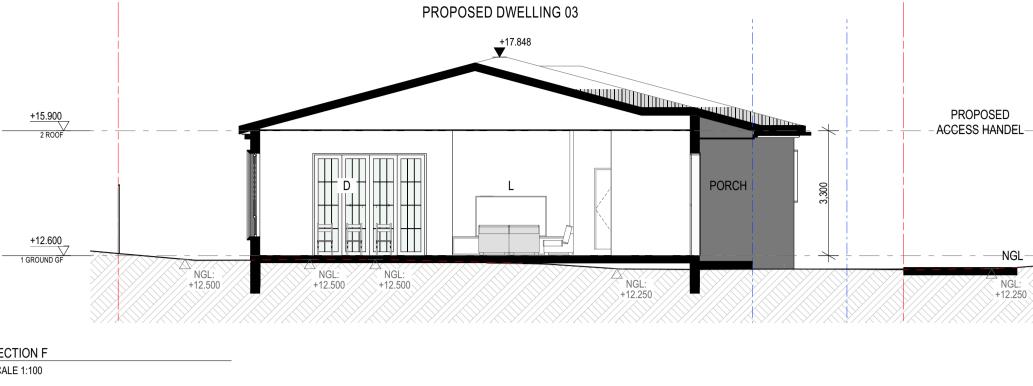
В

Project Number 23-001 Status



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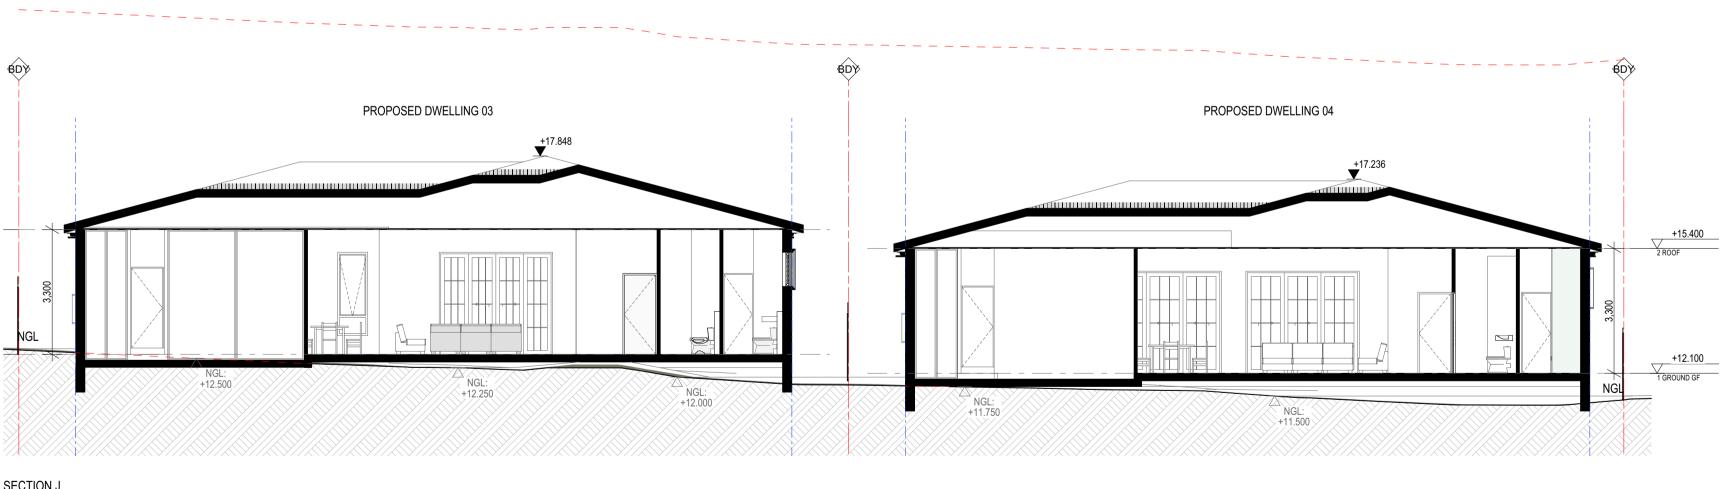
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/ 1 GROUND GF

-NGL

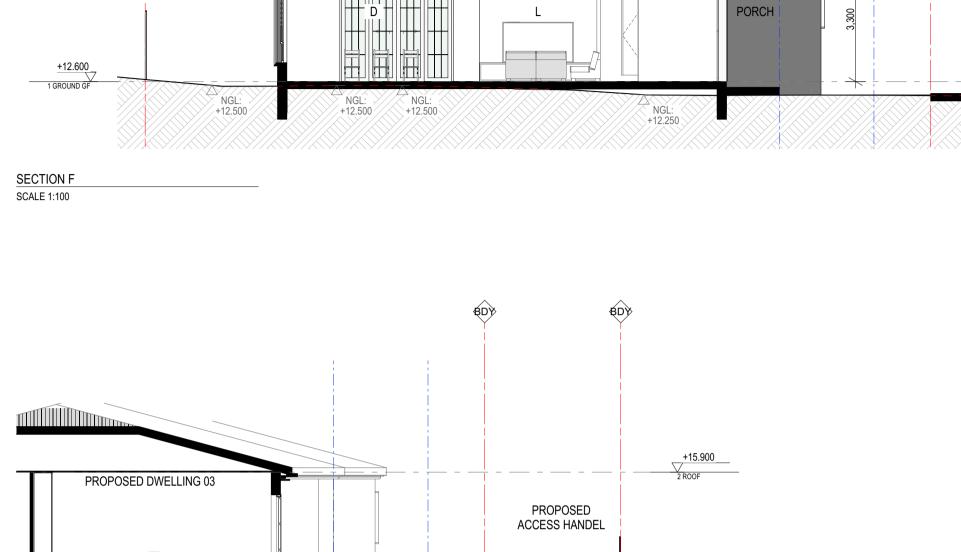+12.250


MAX BUILDING HEIGHT LINE(9m)



SECTION J SCALE 1:100

SECTION H SCALE 1:100

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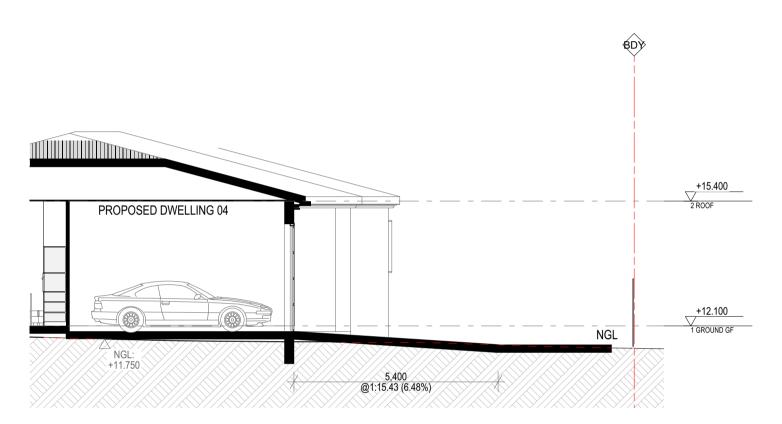

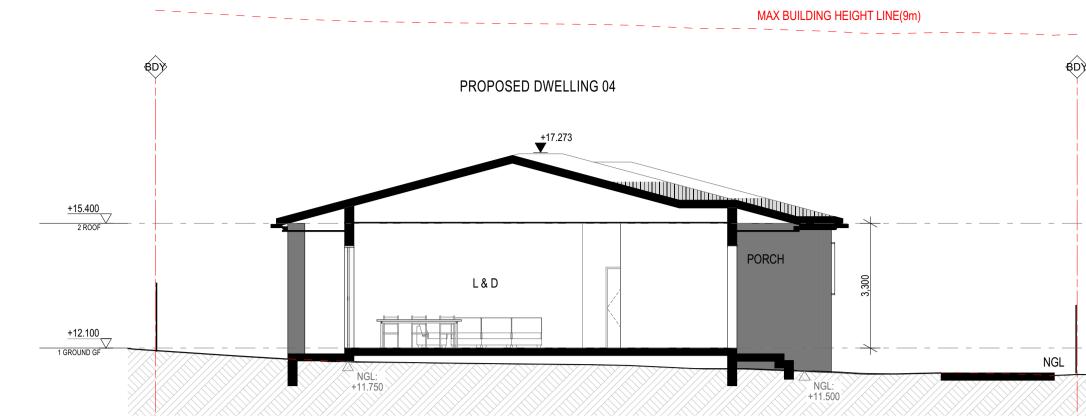
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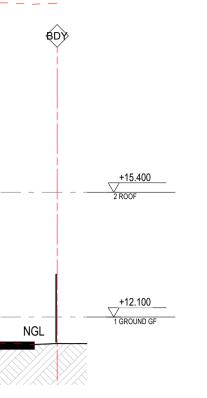


SECTION I SCALE 1:100

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Project RESIDENTIAL DEVELOPMENT

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Drawing Title SECTIONS SECTIONS - DWELLINGS

Scale 1:100


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Project Number 23-001 Status

Drawing Number

DA-0302


Revisio B

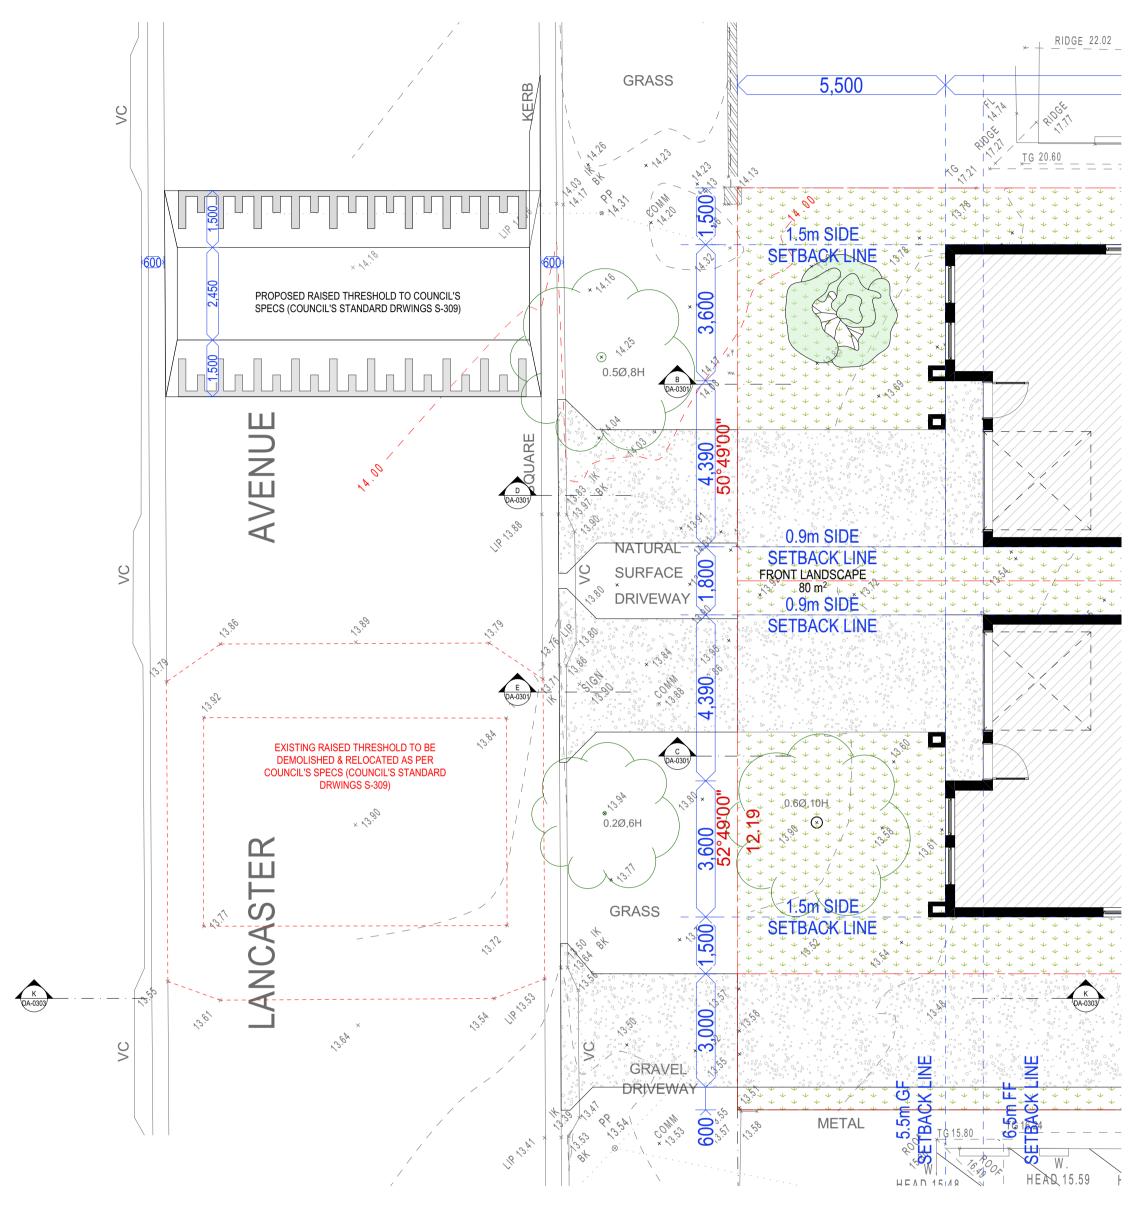

PLAN VIEW SCALE 1:100



SECTION K SCALE 1:100

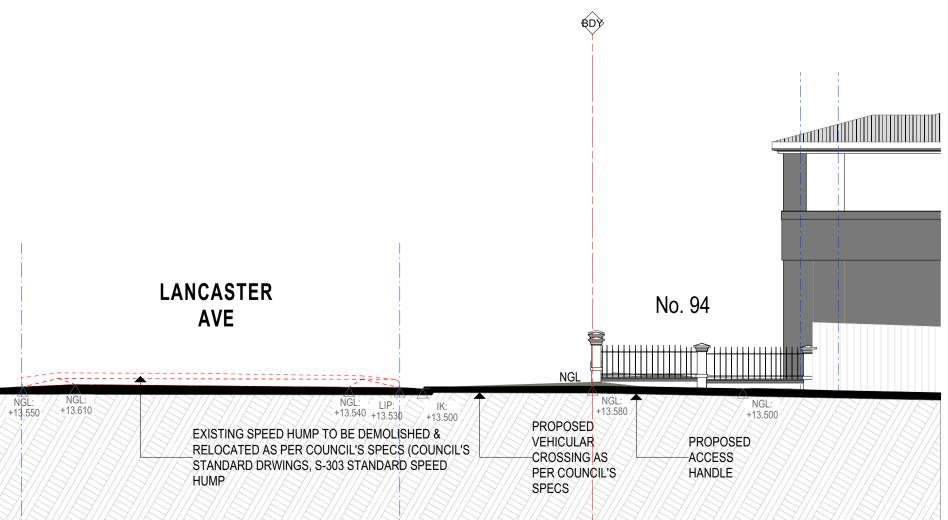

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Project RESIDENTIAL DEVELOPMENT

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Nominated Architects: Ziad Boumelhem Reg no 8008 Georges Jreije Reg no 10993

Drawing Title SECTIONS

SECTIONS - ACCESS HANDEL

Scale 1:100

23-001


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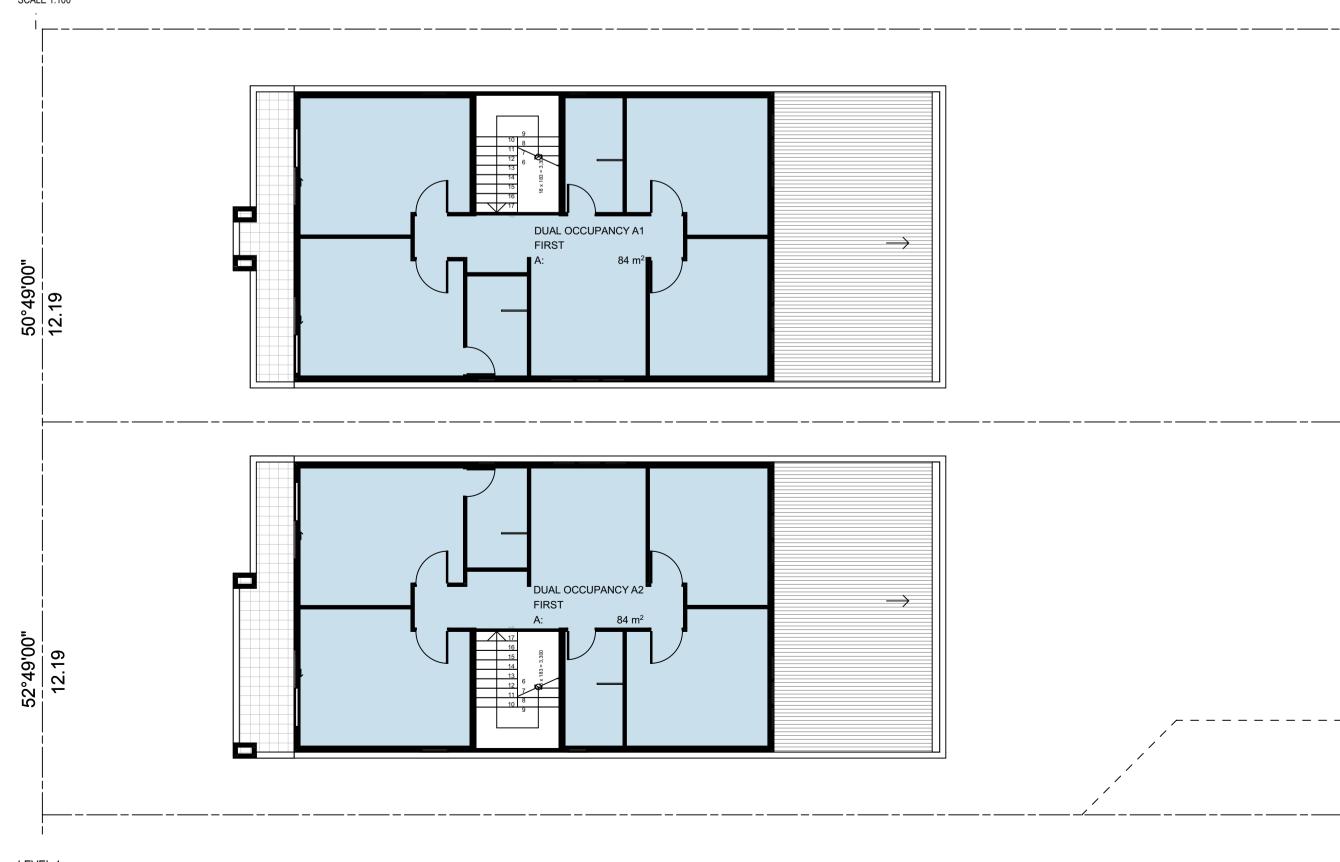
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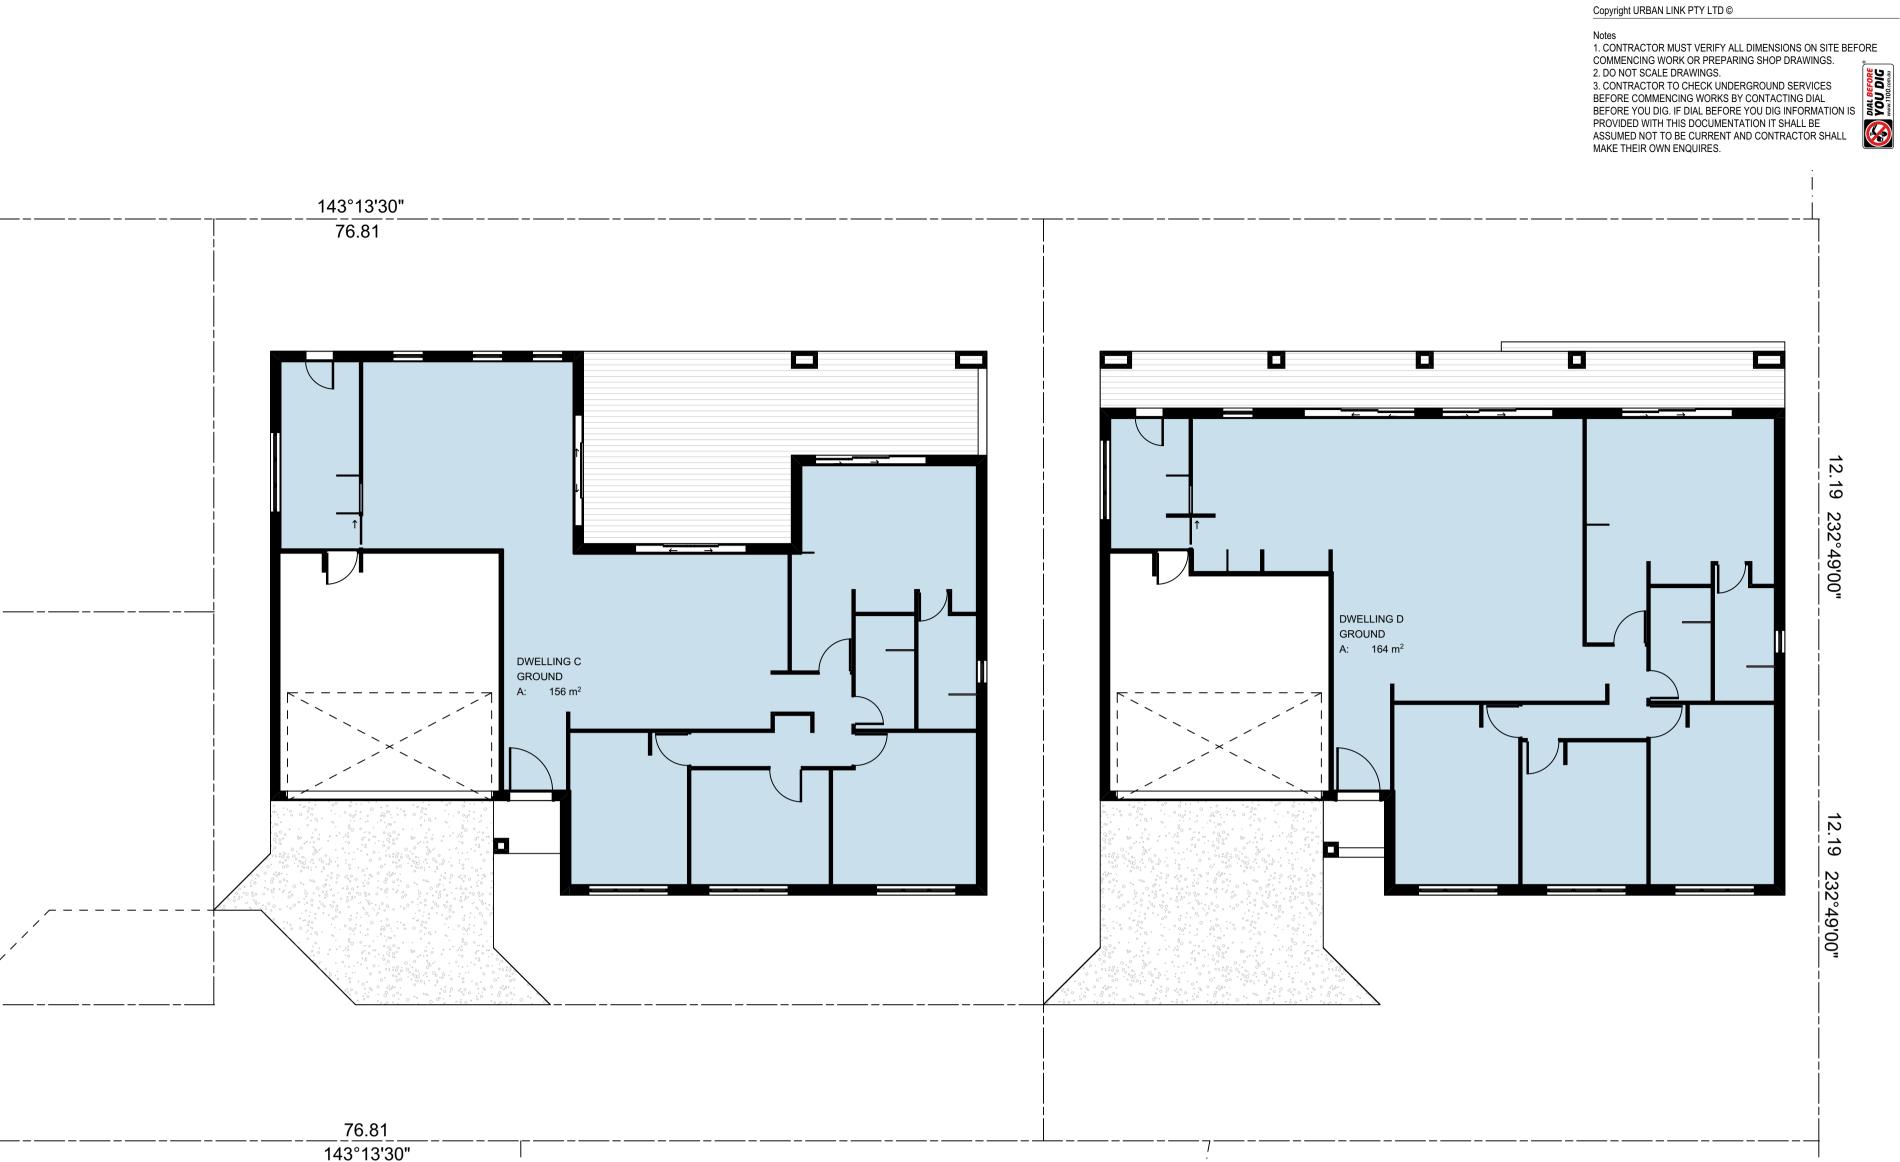


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GROUND GF SCALE 1:100





143°13'30"
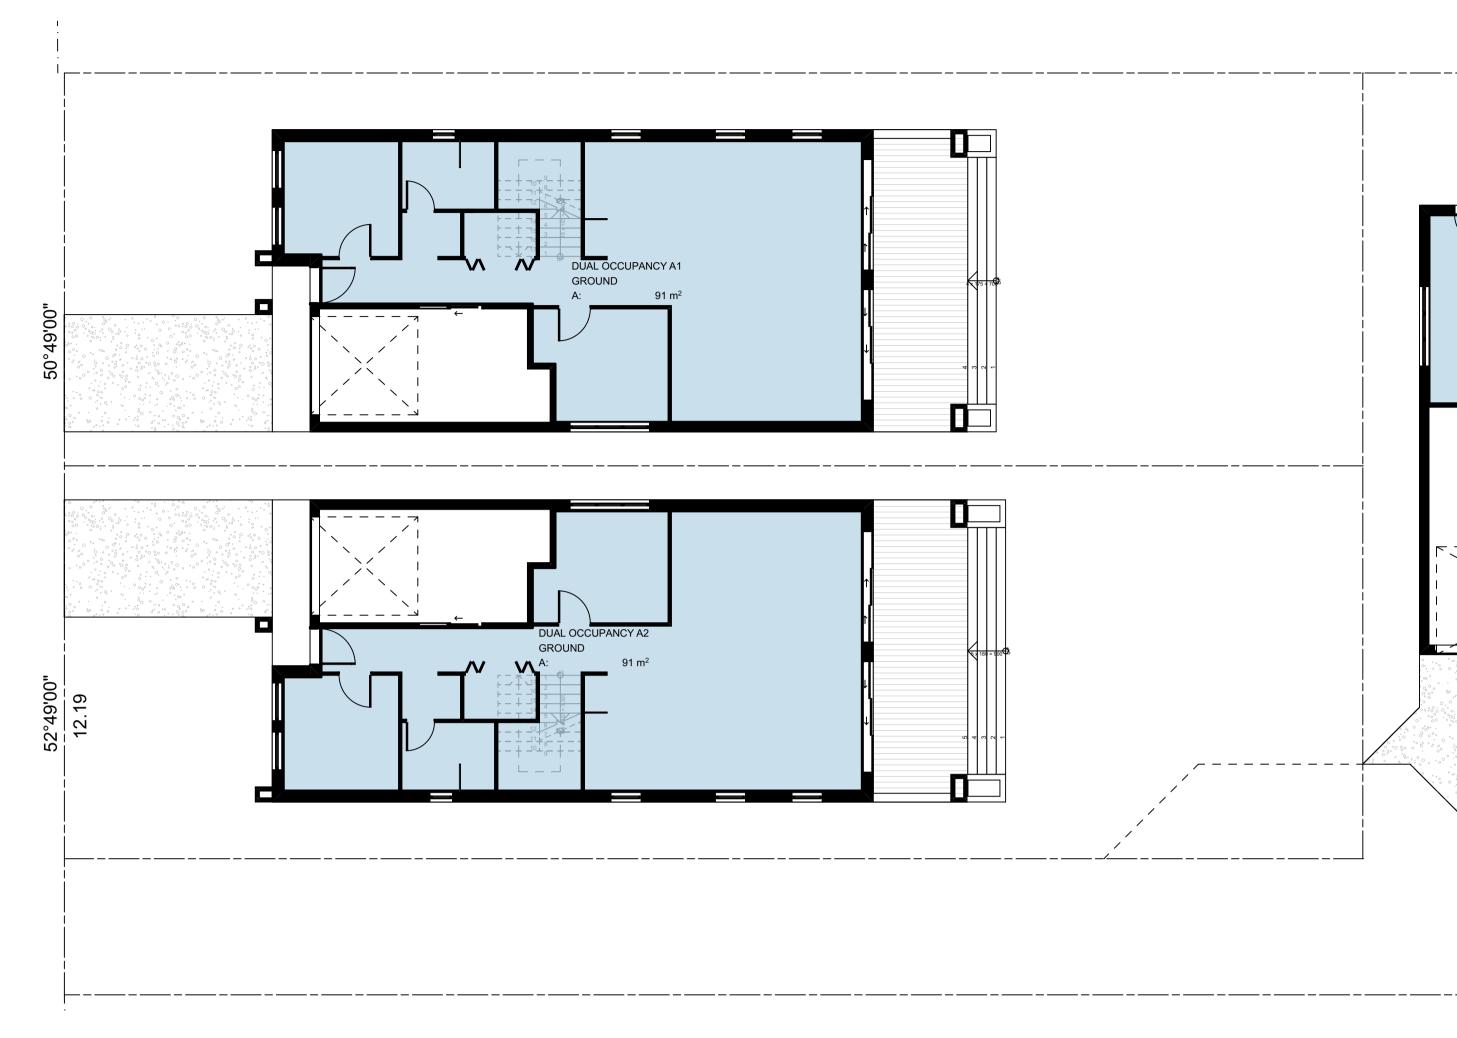
<u>____</u>

	GFA	
	Home Story Name	Area
DUAL OCCUPANCY A1		
	GROUND GF	91
	LEVEL 1	84
		175 m²
DUAL OCCUPANCY A2		
	GROUND GF	91
	LEVEL 1	84
		175 m²
DWELLING C		
	GROUND GF	156
		156 m²
DWELLING D		
	GROUND GF	164
		164 m²
		670 m²

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Project RESIDENTIAL DEVELOPMENT

92 & 94 Lancaster Ave Punchbowl NSW #Site Postcode Australia




23-001

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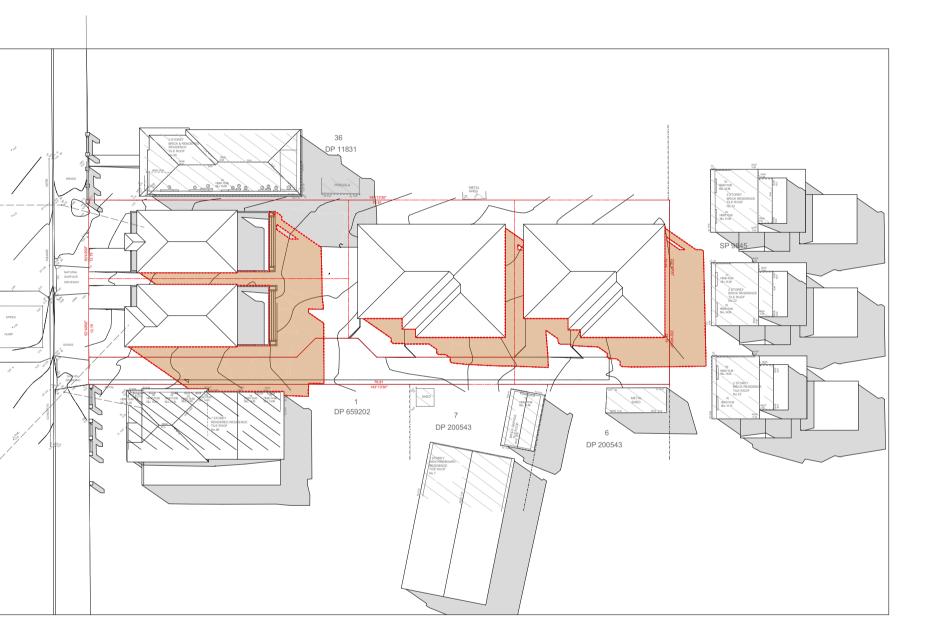



Shadow Diagram 21 June 9am SCALE 1:500

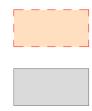

PROPOSED SHADOWS

NEIGHBOUR'S SHADOWS



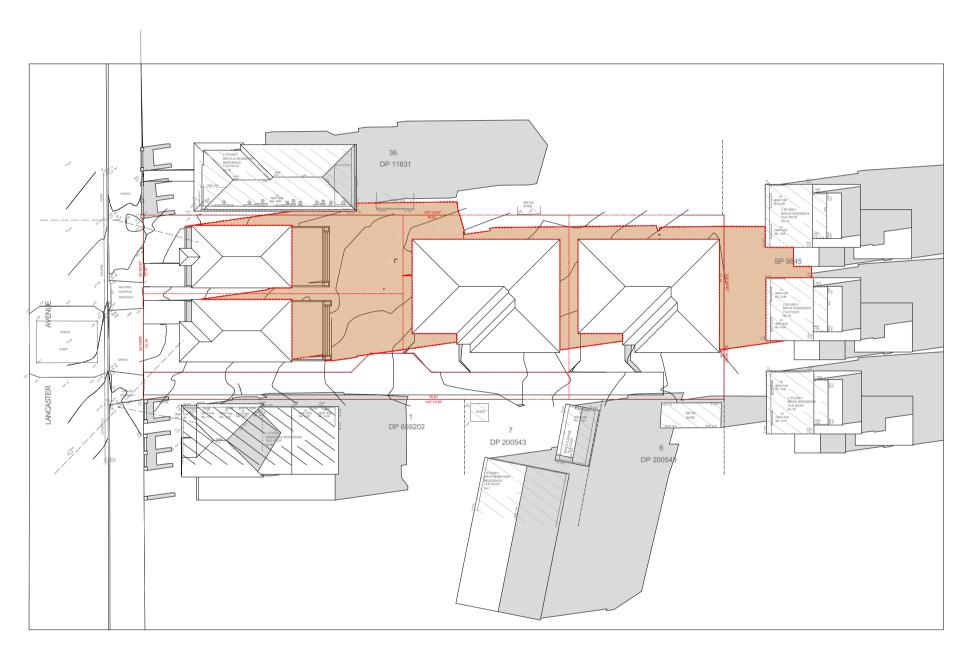

Shadow Diagram 21 June 12pm SCALE 1:500

Shadow Diagram 21 June 3pm SCALE 1:500

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92 & 94 Lancaster Ave Punchbowl NSW #Site Postcode Australia



Nominated Architects: Ziad Boumelhem Reg no 8008 Georges Jreije Reg no 10993


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SHADOW DIAGRAMS WINTER

Scale 1:500

@A1 Sheet Size

Drawing Number Revision **DA-0402 B**

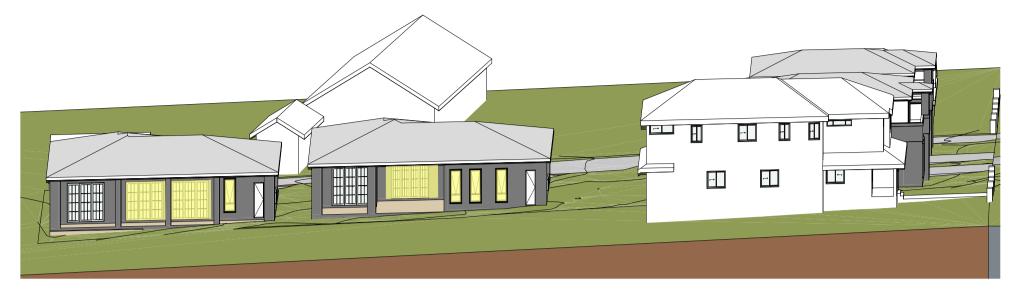


JUNE 21 - 8am SCALE 1:300



JUNE 21 - 10am SCALE 1:300





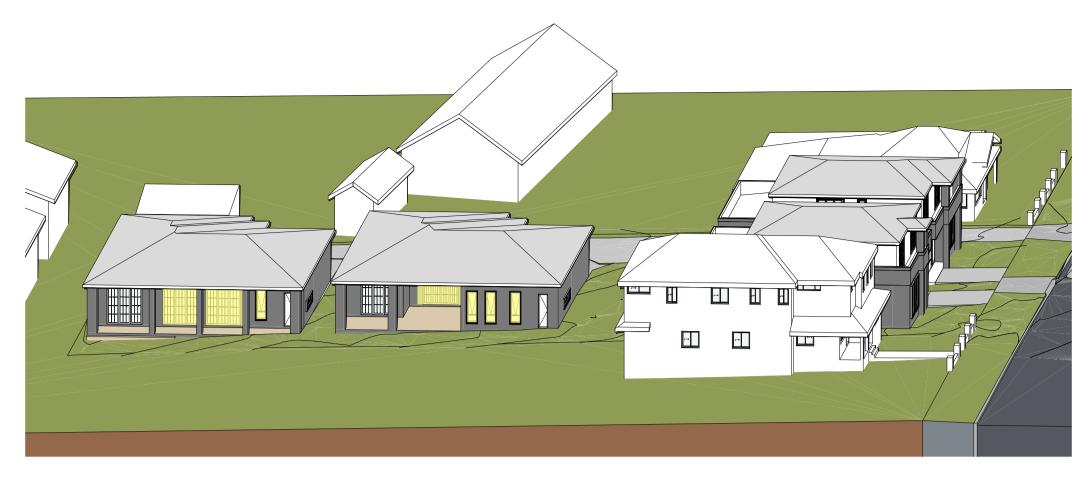

JUNE 21 - 9am SCALE 1:300



JUNE 21 - 11am SCALE 1:300



JUNE 21 - 1pm SCALE 1:300

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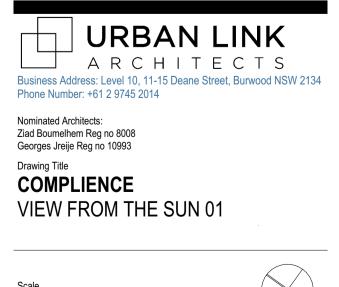
Notes 1. CONTRACTOR MUST VERIFY ALL DIMENSIONS ON SITE BEFORE COMMENCING WORK OR PREPARING SHOP DRAWINGS. 2. DO NOT SCALE DRAWINGS. 3. CONTRACTOR TO CHECK UNDERGROUND SERVICES BEFORE COMMENCING WORKS BY CONTACTING DIAL BEFORE YOU DIG. IF DIAL BEFORE YOU DIG INFORMATION IS PROVIDED WITH THIS DOCUMENTATION IT SHALL BE ASSUMED NOT TO BE CURRENT AND CONTRACTOR SHALL MAKE THEIR OWN ENQUIRES.



BDA SUBMISSIONACONCEPT DESIGN 5/10/2023 20/06/2023 ZB Date App'd Rev Description App'd

Project RESIDENTIAL DEVELOPMENT

92 & 94 Lancaster Ave Punchbowl NSW #Site Postcode Australia



^{Scale} 1:300 Project Number **23-001**

Status


@A1 Sheet Size

Drawing Number **DA-0403**

Revision В



JUNE 21 - 2pm SCALE 1:300

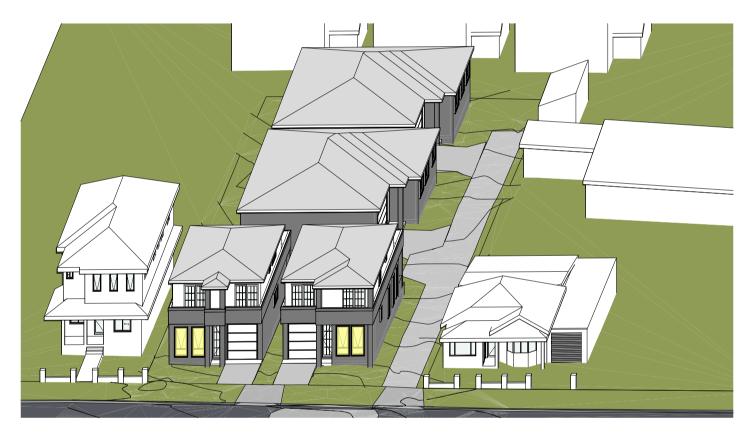

JUNE 21 - 3pm SCALE 1:300



JUNE 21 - 4pm SCALE 1:300

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Notes 1. CONTRACTOR MUST VERIFY ALL DIMENSIONS ON SITE BEFORE COMMENCING WORK OR PREPARING SHOP DRAWINGS. 2. DO NOT SCALE DRAWINGS. 3. CONTRACTOR TO CHECK UNDERGROUND SERVICES BEFORE COMMENCING WORKS BY CONTACTING DIAL BEFORE YOU DIG. IF DIAL BEFORE YOU DIG INFORMATION IS PROVIDED WITH THIS DOCUMENTATION IT SHALL BE ASSUMED NOT TO BE CURRENT AND CONTRACTOR SHALL MAKE THEIR OWN ENQUIRES.






B DA SUBMISSION A CONCEPT DESIGN 5/10/2023 ZB 20/06/2023 ZB Date Rev Description App'd Project

RESIDENTIAL DEVELOPMENT

92 & 94 Lancaster Ave Punchbowl NSW #Site Postcode Australia

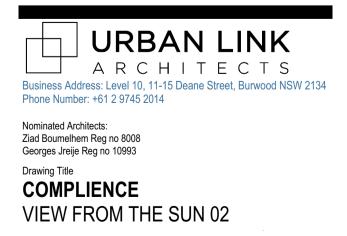

^{Scale} 1:300


@A1 Sheet Size

Project Number **23-001** Status

Drawing Number **DA-0404**

Revision В

BASIX COMMITMENTS 01 - LOT A1, DUAL OCCUPANCY A1

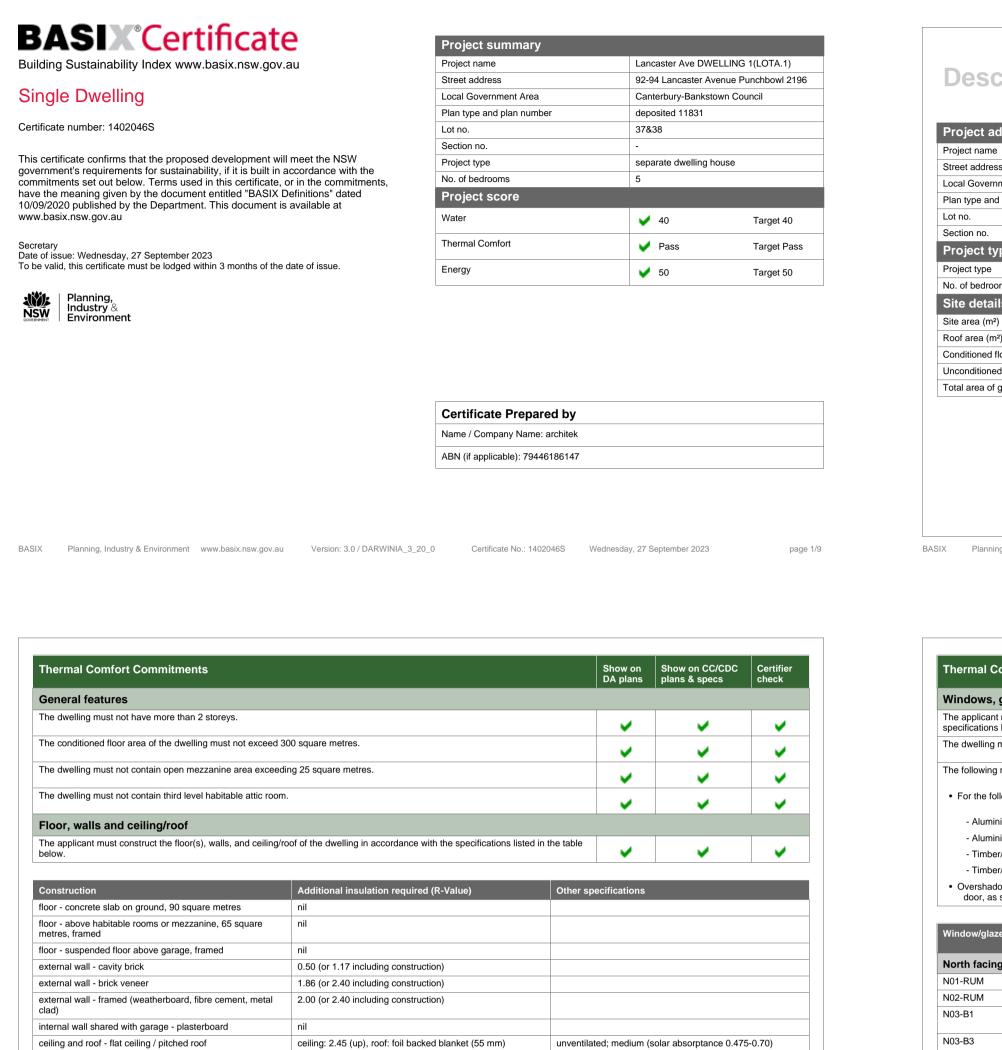

Note • Insulation specified in this Certificate must be installed in accordance with Part 3.12.1.1 of the Building Code of Australia. Note • In some climate zones, insulation should be installed with due consideration of condensation and associated interaction with adjoining building materials.

BASIX Planning, Industry & Environment www.basix.nsw.gov.au Version: 3.0 / DARWINIA_3_20_0 Certificate No.: 1402046S Wednesday, 27 September 2023 page 4/9

Energy Commitments	Show on DA plans	Show on CC/CDC plans & specs	Certifier check
Hot water			
The applicant must install the following hot water system in the development, or a system with a higher energy rating: gas instantaneous with a performance of 3 stars.	~	~	~
Cooling system			
The applicant must install the following cooling system, or a system with a higher energy rating, in at least 1 living area: 3-phase airconditioning; Energy rating: EER 3.0 - 3.5		~	~
The applicant must install the following cooling system, or a system with a higher energy rating, in at least 1 bedroom: 3-phase airconditioning; Energy rating: EER 3.0 - 3.5		~	~
The cooling system must provide for day/night zoning between living areas and bedrooms.		~	~
Heating system			
The living areas must not incorporate any heating system, or any ducting which is designed to accommodate a heating system.		~	~
The bedrooms must not incorporate any heating system, or any ducting which is designed to accommodate a heating system.		~	~
Ventilation		1	
The applicant must install the following exhaust systems in the development:			
At least 1 Bathroom: individual fan, ducted to façade or roof; Operation control: interlocked to light		~	~
Kitchen: no mechanical ventilation (ie. natural); Operation control: n/a		~	~
Laundry: individual fan, ducted to façade or roof; Operation control: manual switch on/off		 	~
Artificial lighting			
The applicant must ensure that the "primary type of artificial lighting" is fluorescent or light emitting diode (LED) lighting in each of the following rooms, and where the word "dedicated" appears, the fittings for those lights must only be capable of accepting fluorescent or light emitting diode (LED) lamps:			
at least 5 of the bedrooms / study;		~	~
Natural lighting		1	1

BASIX Planning, Industry & Environment www.basix.nsw.gov.au Version: 3.0 / DARWINIA_3_20_0 Certificate No.: 1402046S Wednesday, 27 September 2023

owl 2196 Certificate number n/a Climate zone n/a Area adjusted cooling load (MJ/m².year) n/a Area adjusted heating load (MJ/m².year) n/a Ceiling fan in at least one bedroom n/a	Lancaster Ave DWELLING 1(LOTA.1) 92-94 Lancaster Avenue Punchbowl 2196 Canterbury-Bankstown Council Deposited Plan 11831	Project name Street address Local Government Area
Climate zone n/a Area adjusted cooling load (MJ/m².year) n/a Area adjusted heating load (MJ/m².year) n/a Ceiling fan in at least one bedroom n/a	Canterbury-Bankstown Council	
Area adjusted cooling load (MJ/m².year) n/a Area adjusted heating load (MJ/m².year) n/a Ceiling fan in at least one bedroom n/a		Local Government Area
Area adjusted heating load (MJ/m².year) n/a Ceiling fan in at least one bedroom n/a	Deposited Plan 11831	
Ceiling fan in at least one bedroom n/a		Plan type and plan number
	37&38	Lot no.
	-	Section no.
Ceiling fan in at least one living room or n/a other conditioned area		Project type
Project score	separate dwelling house	Project type
	5	No. of bedrooms
Water 🖌 4		Site details
Thermal Comfort 🗸 🗸 P	359	Site area (m²)
· · · · · · · · · · · · · · · · · · ·	146	Roof area (m²)
Energy 5	150.0	Conditioned floor area (m2)
	25.0	Unconditioned floor area (m2)
	125	Total area of garden and lawn (m2)
	146 150.0 25.0	Roof area (m²) Conditioned floor area (m2) Unconditioned floor area (m2)

Thermal Comfort Cor	nmitments				Show on DA plans	Show on CC/CDC plans & specs	Certifier check
Windows, glazed doo	ors and skylight	s					
			evices described in the table below ons must be satisfied for each win		~	 Image: A start of the start of	~
The dwelling may have 1 sk	ylight (<0.7 square	metres) which is not I	listed in the table.		~	~	~
The following requirements	must also be satisfie	ed in relation to each	window and glazed door:				
 For the following glass a 	and frame types, the	certifier check can b	e performed by visual inspection.		· ·	•	
			· · · · · · · · · · · · · · · · · · ·				 ✓
- Aluminium single cle							
- Aluminium double (a	,						
- Timber/uPVC/fibregl	0						
		ar					
- Timber/uPVC/fibregl	()						
Overshadowing building	s/vegetation must b	e of the height and di	istance from the centre and the ba	ase of the window and glazed	~	_	
5	s/vegetation must b	e of the height and di	istance from the centre and the ba	ase of the window and glazed	~	~	~
 Overshadowing building door, as specified in th 	s/vegetation must b e 'overshadowing' c	e of the height and di olumn.		-	vion within	Quarshadowing	~
 Overshadowing building door, as specified in th 	s/vegetation must b	e of the height and di	istance from the centre and the ba	ase of the window and glazed Shading Device (Dimens 10%)	sion within	Overshadowing	~
Overshadowing building door, as specified in th Window/glazed door no.	s/vegetation must b e 'overshadowing' c Maximum	e of the height and di column. Maximum width		Shading Device (Dimens	sion within	Overshadowing	~
Overshadowing building door, as specified in th Window/glazed door no. North facing	s/vegetation must b e 'overshadowing' c Maximum	e of the height and di column. Maximum width		Shading Device (Dimens	sion within	Overshadowing not overshadowed	~
 Overshadowing building door, as specified in th Window/glazed door no. North facing N01-RUM 	s/vegetation must b e 'overshadowing' c Maximum height (mm)	e of the height and di olumn. Maximum width (mm)	Туре	Shading Device (Dimens 10%)	sion within		~
Overshadowing building	s/vegetation must b e 'overshadowing' c Maximum height (mm) 2200	e of the height and di olumn. Maximum width (mm) 1000	Type aluminium, single, clear	Shading Device (Dimens 10%) none		not overshadowed	
Overshadowing building door, as specified in th Window/glazed door no. North facing N01-RUM N02-RUM	s/vegetation must b e 'overshadowing' c Maximum height (mm) 2200 2200	e of the height and di olumn. Maximum width (mm) 1000 1000	Type aluminium, single, clear aluminium, single, clear	Shading Device (Dimens 10%) none eave 450 mm, 200 mm ab	ove head	not overshadowed not overshadowed	
Overshadowing building door, as specified in th Window/glazed door no. North facing N01-RUM N02-RUM N03-B1 N03-B3	s/vegetation must b e 'overshadowing' c Maximum height (mm) 2200 2200 2400	e of the height and di olumn. Maximum width (mm) 1000 1000 2100	Type aluminium, single, clear aluminium, single, clear aluminium, single, clear	Shading Device (Dimension 10%) none none eave 450 mm, 200 mm ab of window or glazed door eave 450 mm, 200 mm ab	ove head	not overshadowed not overshadowed not overshadowed	·
Overshadowing building door, as specified in th Window/glazed door no. North facing N01-RUM N02-RUM N03-B1 N03-B3 East facing	s/vegetation must b e 'overshadowing' c Maximum height (mm) 2200 2200 2400	e of the height and di olumn. Maximum width (mm) 1000 1000 2100	Type aluminium, single, clear aluminium, single, clear aluminium, single, clear	Shading Device (Dimension 10%) none none eave 450 mm, 200 mm ab of window or glazed door eave 450 mm, 200 mm ab	ove head	not overshadowed not overshadowed not overshadowed	
Overshadowing building door, as specified in th Window/glazed door no. North facing N01-RUM N02-RUM N03-B1	s/vegetation must b e 'overshadowing' c Maximum height (mm) 2200 2200 2400 2400	e of the height and di olumn. Maximum width (mm) 1000 2100 2100	Type aluminium, single, clear aluminium, single, clear aluminium, single, clear aluminium, single, clear	Shading Device (Dimension 10%) none none eave 450 mm, 200 mm ab of window or glazed door eave 450 mm, 200 mm ab of window or glazed door	ove head	not overshadowed not overshadowed not overshadowed not overshadowed	

The applicant must install a window The applicant must install a window Other The applicant must install a gas con The applicant must construct each definitions. The applicant must install a fixed of	The applicant must install a window Other The applicant must install a gas con The applicant must construct each definitions.
Other The applicant must install a gas coo The applicant must construct each definitions.	Other The applicant must install a gas con The applicant must construct each definitions.
The applicant must install a gas count of the applicant must construct each definitions.	The applicant must install a gas count of the applicant must construct each definitions.
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definitions.	definitions.
The applicant must install a fixed or	The applicant must install a fixed o

page 7/9

of project

Lancaster Ave DWELLING 1(LOTA.1)
92-94 Lancaster Avenue Punchbowl 2196
Canterbury-Bankstown Council
Deposited Plan 11831
37&38
-
separate dwelling house
5
359
146
150.0
25.0
125

Assessor number	n/a	
Certificate number	n/a	
Climate zone	n/a	
Area adjusted cooling load (MJ/m².year)	n/a	
Area adjusted heating load (MJ/m².year)	n/a	
Ceiling fan in at least one bedroom	n/a	
Ceiling fan in at least one living room or other conditioned area	n/a	
Project score		
Water	V 40	Target 40
Thermal Comfort	V Pass	Target Pass
Energy	50	Target 50

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page 8/9

ter Commitments	Show on DA plans	Show on CC/CDC plans & specs	Certifier check
tures			
applicant must install showerheads with a minimum rating of 3 star (> 4.5 but <= 6 L/min) in all showers in the development.		~	~
applicant must install a toilet flushing system with a minimum rating of 4 star in each toilet in the development.		 	~
applicant must install taps with a minimum rating of 5 star in the kitchen in the development.		~	
applicant must install basin taps with a minimum rating of 5 star in each bathroom in the development.		~	
ernative water			
nwater tank			
applicant must install a rainwater tank of at least 3200 litres on the site. This rainwater tank must meet, and be installed in ordance with, the requirements of all applicable regulatory authorities.	~	 	~
applicant must configure the rainwater tank to collect rain runoff from at least 145 square metres of the roof area of the elopment (excluding the area of the roof which drains to any stormwater tank or private dam).		 	~
applicant must connect the rainwater tank to:			
at least one outdoor tap in the development (Note: NSW Health does not recommend that rainwater be used for human consumption in areas with potable water supply.)		 Image: A set of the set of the	~

Window/glazed door no.	Maximum height (mm)	Maximum width (mm)	Туре	Shading Device (Dimension within 10%)	Overshadowing
E04-DIN	2200	800	aluminium, single, clear	none	not overshadowed
E05-B3	1200	800	aluminium, single, clear	eave 450 mm, 200 mm above head of window or glazed door	not overshadowed
E06-BATH	600	600	aluminium, single, clear	eave 450 mm, 200 mm above head of window or glazed door	not overshadowed
South facing					
S01-LIV	3000	2700	aluminium, single, clear	verandah 2500 mm, 2700 mm above base of window or glazed door	not overshadowed
S02-DIN	3000	2700	aluminium, single, clear	verandah 2500 mm, 2700 mm above base of window or glazed door	not overshadowed
S03-B2	1200	2100	aluminium, single, clear	eave 450 mm, 200 mm above head of window or glazed door	not overshadowed
S04-B4	1200	2100	aluminium, single, clear	eave 450 mm, 200 mm above head of window or glazed door	not overshadowed
West facing					
W01-GUEST	1000	2100	aluminium, single, clear	none	2-4 m high, 2-5 m away
W02-BATH	600	600	aluminium, single, clear	eave 450 mm, 200 mm above head of window or glazed door	2-4 m high, 2-5 m away
W03-FAMILY	600	2100	aluminium, single, clear	eave 450 mm, 200 mm above head of window or glazed door	2-4 m high, 2-5 m away

	Show on DA plans	Show on CC/CDC plans & specs	Certifier check
and/or skylight in the kitchen of the dwelling for natural lighting.	~	~	~
and/or skylight in 3 bathroom(s)/toilet(s) in the development for natural lighting.	~	~	~
top & electric oven in the kitchen of the dwelling.		~	
frigerator space in the development so that it is "well ventilated", as defined in the BASIX		~	
door clothes drying line as part of the development.		~	

BASIX Planning, Industry & Environment www.basix.nsw.gov.au Version: 3.0 / DARWINIA_3_20_0 Certificate No.: 1402046S Wednesday, 27 September 2023

In these commitments, "applicant" mea	ns the person carrying out the development.
Commitments identified with a vin the development application is to be lodged	e "Show on DA plans" column must be shown on the plans accompa d for the proposed development).
Commitments identified with a v in th certificate / complying development cert	e "Show on CC/CDC plans and specs" column must be shown in the tificate for the proposed development.
Commitments identified with a v in th final) for the development may be issue	e "Certifier check" column must be certified by a certifying authority a ed.

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Notes 1. CONTRACTOR MUST VERIFY ALL DIMENSIONS ON SITE BEFORE COMMENCING WORK OR PREPARING SHOP DRAWINGS.

2. DO NOT SCALE DRAWINGS. 3. CONTRACTOR TO CHECK UNDERGROUND SERVICES BEFORE COMMENCING WORKS BY CONTACTING DIAL BEFORE YOU DIG. IF DIAL BEFORE YOU DIG INFORMATION IS PROVIDED WITH THIS DOCUMENTATION IT SHALL BE ASSUMED NOT TO BE CURRENT AND CONTRACTOR SHALL MAKE THEIR OWN ENQUIRES.



BASIX	Planning, Industry & Environment	www.basix.nsw.gov.au	Version: 3.0 / DARWINIA_3_20_0	Certificate No.: 1402046S	Wednesday, 27 September 2023

iying the development ap	plication for the proposed development (if	а
plans and specifications a	accompanying the application for a constru	uction
s having been fulfilled, be	fore a final occupation certificate(either inte	erim or
ertificate No.: 1402046S	Wednesday, 27 September 2023	page 9

B DA SUBMISSION Rev Description

Project

page 6/9

5/10/2023 ZB Date App'd

RESIDENTIAL DEVELOPMENT

92 & 94 Lancaster Ave Punchbowl NSW #Site Postcode Australia



Phone Number: +61 2 9745 2014 Nominated Architects:

Ziad Boumelhem Reg no 8008 Georges Jreije Reg no 10993 Drawing Title


COMPLIENCE BASIX COMMITMENTS 01

Scale 1:1.30

@A1 Sheet Siz

Project Number 23-001 Status

BASIX COMMITMENTS 02 - LOT A2, DUAL OCCUPANCY A2

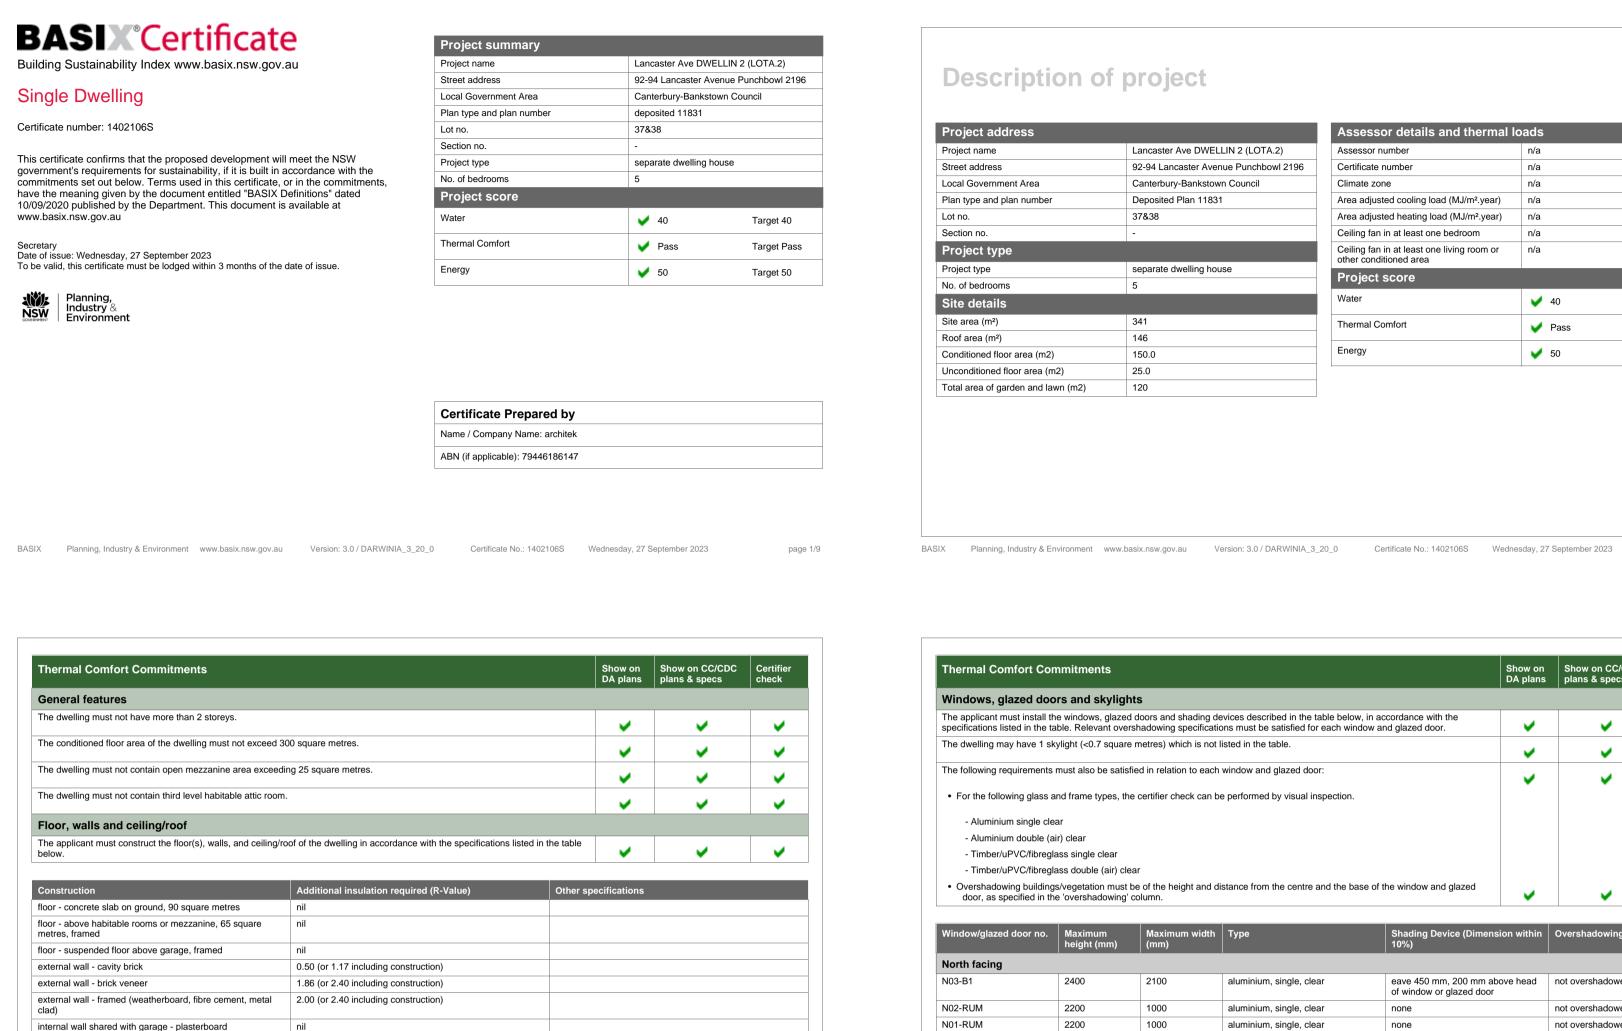

East facing E01-GUEST 1000 E03-FAMILY 600

2400

2200

2200

2400

BASIX Planning, Industry & Environment

N03-B3

Energy Commitments The applicant must install a windo The applicant must install a windo Other The applicant must install a gas of The applicant must construct each definitions. The applicant must install a fixed of							
The applicant must install a windo Other The applicant must install a gas of The applicant must construct each definitions.	Ene	ergy C	Com	mitr	nen	ts	
Other The applicant must install a gas of The applicant must construct each definitions.	The	applica	int m	ust in	stall	a win	do
The applicant must install a gas of The applicant must construct each definitions.	The	applica	int m	ust in	stall	a win	do
The applicant must construct each definitions.	Oth	er					
definitions.	The	applica	int m	ust in	stall	a gas	6 CC
The applicant must install a fixed o			int m	ust co	onstr	uct ea	ach
	The	applica	int m	ust in	stall	a fixe	ed o

page 7/9

internal wall shared with garage - plasterboard ceiling and roof - flat ceiling / pitched roof ceiling: 2.45 (up), roof: foil backed blanket (55 mm) unventilated; medium (solar absorptance 0.475-0.70) Note • Insulation specified in this Certificate must be installed in accordance with Part 3.12.1.1 of the Building Code of Australia. Note • In some climate zones, insulation should be installed with due consideration of condensation and associated interaction with adjoining building materials. BASIX Planning, Industry & Environment www.basix.nsw.gov.au Version: 3.0 / DARWINIA_3_20_0 Certificate No.: 1402106S Wednesday, 27 September 2023 page 4/9

Energy Commitments	Show on DA plans	Show on CC/CDC plans & specs	Certifier check
Hot water			
The applicant must install the following hot water system in the development, or a system with a higher energy rating: gas instantaneous with a performance of 3 stars.	~	~	~
Cooling system			
The applicant must install the following cooling system, or a system with a higher energy rating, in at least 1 living area: 3-phase airconditioning; Energy rating: EER 3.0 - 3.5		~	~
The applicant must install the following cooling system, or a system with a higher energy rating, in at least 1 bedroom: 3-phase airconditioning; Energy rating: EER 3.0 - 3.5		 Image: A set of the set of the	~
The cooling system must provide for day/night zoning between living areas and bedrooms.		 Image: A set of the set of the	~
Heating system			
The living areas must not incorporate any heating system, or any ducting which is designed to accommodate a heating system.		~	~
The bedrooms must not incorporate any heating system, or any ducting which is designed to accommodate a heating system.		 Image: A set of the set of the	~
Ventilation			
The applicant must install the following exhaust systems in the development:			
At least 1 Bathroom: individual fan, ducted to façade or roof; Operation control: interlocked to light		~	~
Kitchen: no mechanical ventilation (ie. natural); Operation control: n/a		 Image: A set of the set of the	~
Laundry: individual fan, ducted to façade or roof; Operation control: manual switch on/off		 Image: A set of the set of the	~
Artificial lighting			
The applicant must ensure that the "primary type of artificial lighting" is fluorescent or light emitting diode (LED) lighting in each of the following rooms, and where the word "dedicated" appears, the fittings for those lights must only be capable of accepting fluorescent or ight emitting diode (LED) lamps:			
at least 5 of the bedrooms / study;		~	~
Natural lighting		1	

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Description of project

Lancaster Ave DWELLIN 2 (LOTA.2)
92-94 Lancaster Avenue Punchbowl 2196
Canterbury-Bankstown Council
Deposited Plan 11831
37&38
-
separate dwelling house
5
341
146
150.0
25.0
120

Assessor number	n/a	
Certificate number	n/a	
Climate zone	n/a	
Area adjusted cooling load (MJ/m².year)	n/a	
Area adjusted heating load (MJ/m².year)	n/a	
Ceiling fan in at least one bedroom	n/a	
Ceiling fan in at least one living room or other conditioned area	n/a	
Project score		
Water	V 40	Target 40
Thermal Comfort	V Pass	Target Pass
Energy	50	Target 50

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page 8/9

Schedule of BASIX commitments
The commitments set out below regulate how the proposed development is to be carried out. It is a development certificate issued, for the proposed development, that BASIX commitments be complete
Water Commitments
Fixtures
The applicant must install showerheads with a minimum rating of 3 star (> 4.5 but <= 6 L/min) in all showers
The applicant must install a toilet flushing system with a minimum rating of 4 star in each toilet in the develo
The applicant must install taps with a minimum rating of 5 star in the kitchen in the development.
The applicant must install basin taps with a minimum rating of 5 star in each bathroom in the development.
Alternative water
Rainwater tank
The applicant must install a rainwater tank of at least 3200 litres on the site. This rainwater tank must meet, accordance with, the requirements of all applicable regulatory authorities.
The applicant must configure the rainwater tank to collect rain runoff from at least 145 square metres of the development (excluding the area of the roof which drains to any stormwater tank or private dam).
The applicant must connect the rainwater tank to:
 at least one outdoor tap in the development (Note: NSW Health does not recommend that rainwater be consumption in areas with potable water supply.)

ents					Show on CC/CDC plans & specs	Certifier check
d skyligl	nts					
		evices described in the table below ons must be satisfied for each wind		~	~	~
<0.7 squar	e metres) which is not l	isted in the table.		~	 	~
		window and glazed door: e performed by visual inspection.		~	~	~
le clear						
ble (air) cle ation must hadowing'	be of the height and di	stance from the centre and the ba	se of the window and glazed		~	
mum nt (mm)	Maximum width (mm)	Туре	Shading Device (Dimen 10%)	sion within	Overshadowing	
	2100	aluminium, single, clear	eave 450 mm, 200 mm a of window or glazed door	oove head	not overshadowed	
	1000	aluminium, single, clear	none		not overshadowed	
	1000	aluminium, single, clear	none		not overshadowed	
	2100	aluminium, single, clear	eave 450 mm, 200 mm a of window or glazed door	oove head	not overshadowed	
	2100	aluminium, single, clear	none		2-4 m high, 2-5 m away	/

nt	www.basix.nsw.gov.au	Version: 3.0 / DARWINIA_3_20_0	Certificate No.: 1402106S	Wednesday, 27 September 2023	page 5/9
	0				1 0

indow/glazed door no.	Maximum height (mm)	Maximum width (mm)	Туре	Shading Device (Dimension within 10%)	Overshadowing
E02-ENS	600	600	aluminium, single, clear	eave 450 mm, 200 mm above head of window or glazed door	2-4 m high, 2-5 m away
South facing					
S04-B4	1200	2100	aluminium, single, clear	eave 450 mm, 200 mm above head of window or glazed door	not overshadowed
S01-LIV	3000	2700	aluminium, single, clear	verandah 2500 mm, 2700 mm above base of window or glazed door	not overshadowed
S02-DIN	3000	2700	aluminium, single, clear	verandah 2500 mm, 2700 mm above base of window or glazed door	not overshadowed
S03-B2	1200	2100	aluminium, single, clear	eave 450 mm, 200 mm above head of window or glazed door	not overshadowed
West facing					
W01-BATH	900	600	aluminium, single, clear	none	not overshadowed
W02-KIT	2200	800	aluminium, single, clear	none	not overshadowed
W03-DIN	2200	800	aluminium, single, clear	none	not overshadowed
W04-DIN	2200	800	aluminium, single, clear	none	not overshadowed
W05-B3	1200	800	aluminium, single, clear	eave 450 mm, 200 mm above head of window or glazed door	not overshadowed
W06-BATH	900	600	aluminium, single, clear	eave 450 mm, 200 mm above head of window or glazed door	not overshadowed

Show on DA plans	Show on CC/CDC plans & specs	Certifier check
>	~	~
~	~	~
	~	
	~	
	~	
	DA plans	DA plans plans & specs

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In the	ese commitm	ents, "applica	nt" means	s the perso	n carrying o	out the developm	ient.		
		ntified with a l lication is to b	•			olumn must be s lopment).	hown on the p	lans accomp	ban
			•			ans and specs" o development.	olumn must be	e shown in th	ne j
		ntified with a lopment may	•		heck" colun	nn must be certif	ed by a certify	ing authority	/ as

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Notes 1. CONTRACTOR MUST VERIFY ALL DIMENSIONS ON SITE BEFORE COMMENCING WORK OR PREPARING SHOP DRAWINGS.

2. DO NOT SCALE DRAWINGS. 3. CONTRACTOR TO CHECK UNDERGROUND SERVICES BEFORE COMMENCING WORKS BY CONTACTING DIAL BEFORE YOU DIG. IF DIAL BEFORE YOU DIG INFORMATION IS PROVIDED WITH THIS DOCUMENTATION IT SHALL BE ASSUMED NOT TO BE CURRENT AND CONTRACTOR SHALL MAKE THEIR OWN ENQUIRES.



Water Commitments	Show on DA plans	Show on CC/CDC plans & specs	Certifie check
Fixtures			
The applicant must install showerheads with a minimum rating of 3 star (> 4.5 but <= 6 L/min) in all showers in the development.		~	
The applicant must install a toilet flushing system with a minimum rating of 4 star in each toilet in the development.		 ✓ 	~
The applicant must install taps with a minimum rating of 5 star in the kitchen in the development.		 	
The applicant must install basin taps with a minimum rating of 5 star in each bathroom in the development.		 Image: A set of the set of the	
Alternative water			
Rainwater tank			
The applicant must install a rainwater tank of at least 3200 litres on the site. This rainwater tank must meet, and be installed in accordance with, the requirements of all applicable regulatory authorities.	~	~	~
The applicant must configure the rainwater tank to collect rain runoff from at least 145 square metres of the roof area of the development (excluding the area of the roof which drains to any stormwater tank or private dam).		 Image: A set of the set of the	~
The applicant must connect the rainwater tank to:			
 at least one outdoor tap in the development (Note: NSW Health does not recommend that rainwater be used for human consumption in areas with potable water supply.) 		 Image: A set of the set of the	~

BASIX	Planning, Industry & Environment	www.basix.nsw.gov.au	Version: 3.0 / DARWINIA_3_20_0	Certificate No.: 1402106S	Wednesday, 27 September 2023

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B DA SUBMISSION Rev Description

Project

5/10/2023 ZB Date App'd

RESIDENTIAL DEVELOPMENT

92 & 94 Lancaster Ave Punchbowl NSW #Site Postcode Australia



Phone Number: +61 2 9745 2014 Nominated Architects:

Ziad Boumelhem Reg no 8008 Georges Jreije Reg no 10993 Drawing Title

COMPLIENCE BASIX COMMITMENTS 02


Scale 1:1.30

Status

@A1 Sheet Siz

Project Number 23-001

BASIX COMMITMENTS 03 - LOT B, DWELLING B

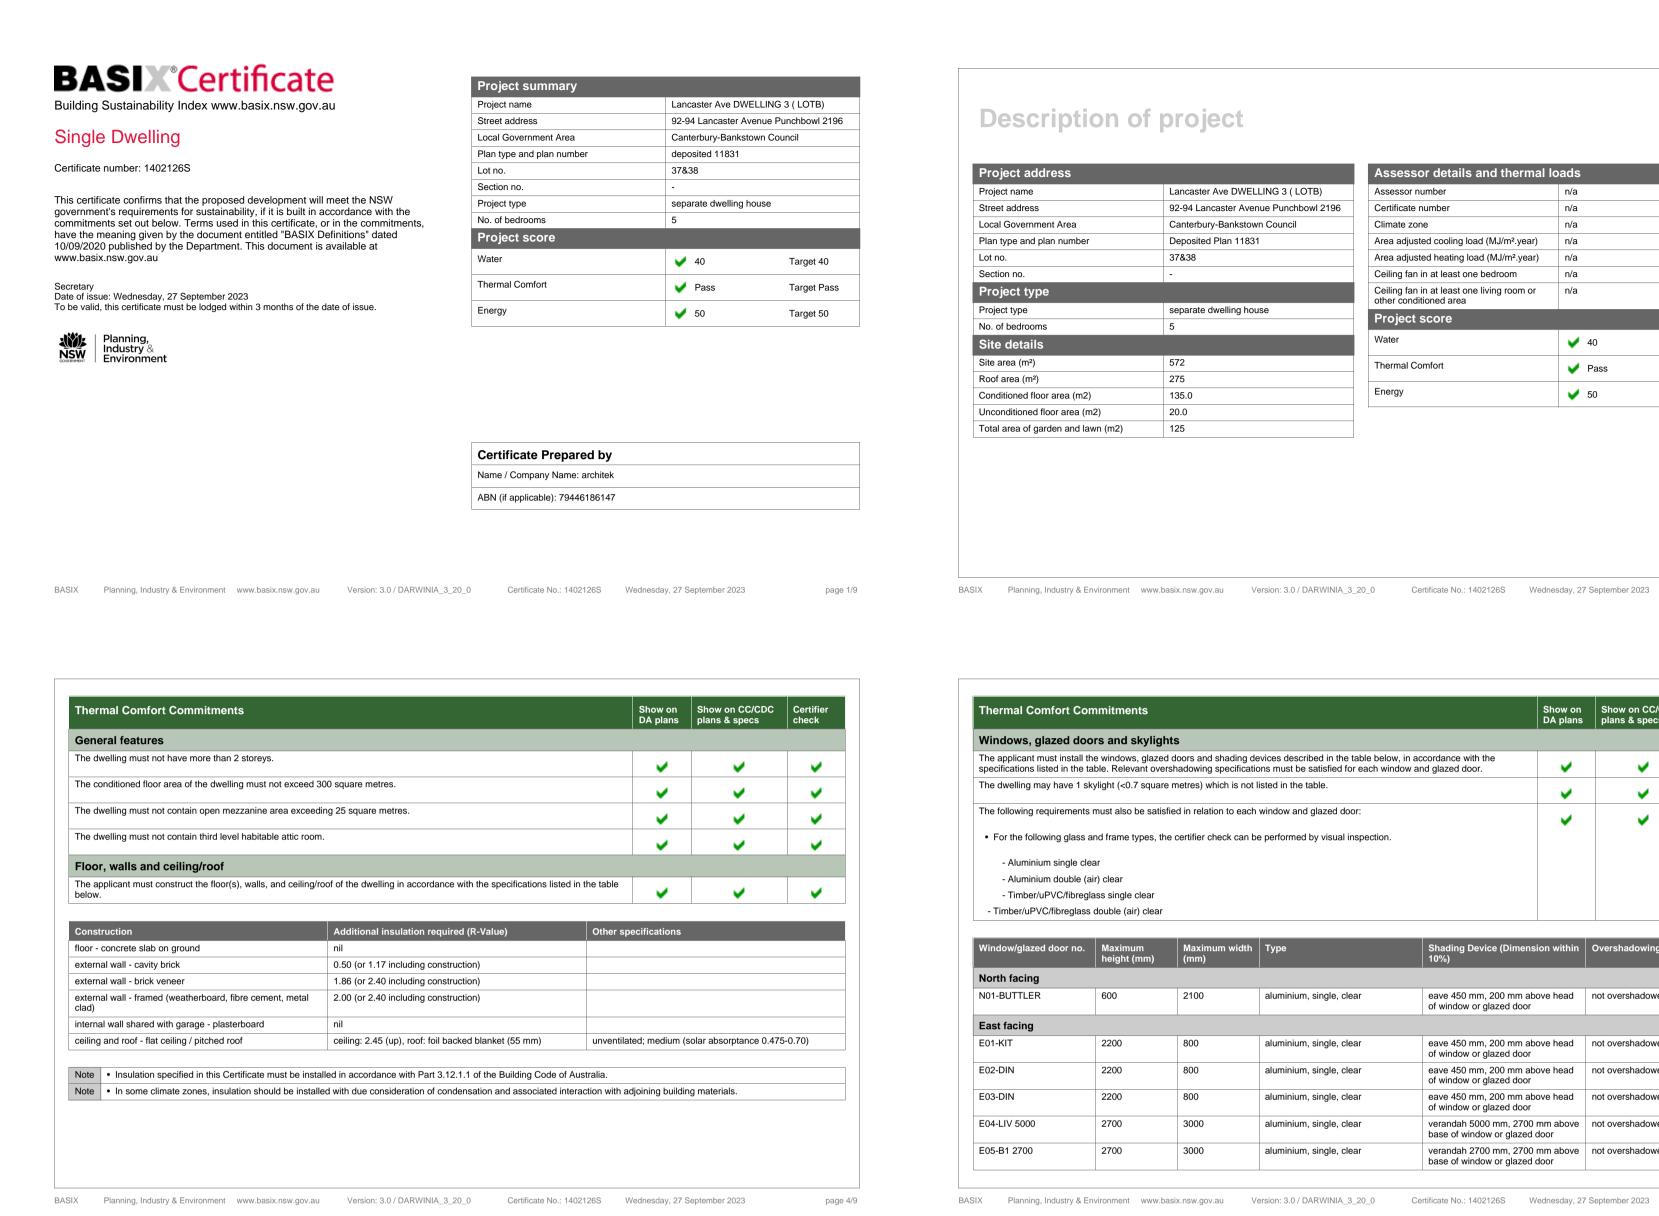

Show onShow on CC/CDCCertifieDA plansplans & specscheck Energy Commitments Hot water The applicant must install the following hot water system in the development, or a system with a higher energy rating: gas instantaneous with a performance of 3 stars. Cooling system The applicant must install the following cooling system, or a system with a higher energy rating, in at least 1 living area: 3-phase airconditioning; Energy rating: EER 3.0 - 3.5 **~** Image: A set of the The applicant must install the following cooling system, or a system with a higher energy rating, in at least 1 bedroom: 3-phase airconditioning; Energy rating: EER 3.0 - 3.5 ~ ~ The cooling system must provide for day/night zoning between living areas and bedrooms. Image: A set of the **~** Heating system The living areas must not incorporate any heating system, or any ducting which is designed to accommodate a heating system. ✓ . ~ The bedrooms must not incorporate any heating system, or any ducting which is designed to accommodate a heating system. -**~** Ventilation The applicant must install the following exhaust systems in the development: At least 1 Bathroom: individual fan, ducted to façade or roof; Operation control: interlocked to light ~ ~~ Kitchen: no mechanical ventilation (ie. natural); Operation control: n/a ~~ Laundry: individual fan, ducted to façade or roof; Operation control: manual switch on/off -~ Artificial lighting The applicant must ensure that the "primary type of artificial lighting" is fluorescent or light emitting diode (LED) lighting in each of the following rooms, and where the word "dedicated" appears, the fittings for those lights must only be capable of accepting fluorescent or light emitting diode (LED) lamps: at least 4 of the bedrooms / study; **~** ~ Natural lighting

BASIX Planning, Industry & Environment www.basix.nsw.gov.au Version: 3.0 / DARWINIA_3_20_0 Certificate No.: 1402126S Wednesday, 27 September 2023

The applicant must construct ea definitions.	The applicant must install a wind Other The applicant must install a gas The applicant must construct ea definitions.	The applicant must install a wind Other The applicant must install a gas The applicant must construct ea definitions.	En	ergy	Comn	nitme	nts
Other The applicant must install a gas The applicant must construct ea definitions.	Other The applicant must install a gas The applicant must construct ea definitions.	Other The applicant must install a gas The applicant must construct ea definitions.	The	applic	ant mus	st insta	ll a win
The applicant must install a gas The applicant must construct ea definitions.	The applicant must install a gas The applicant must construct ea definitions.	The applicant must install a gas The applicant must construct ea definitions.	The	applic	ant mus	st insta	ll a win
definitions.	The applicant must construct ea definitions.	The applicant must construct ea definitions.	Otł	her			
definitions.	The applicant must construct ea definitions. The applicant must install a fixed	definitions.	The	applic	ant mus	st insta	ll a gas
The applicant must install a fixed	The applicant must install a fixed	The applicant must install a fixed				st const	truct ea
			The	applic	ant mus	st insta	ll a fixe

page 7/9

Description of project

Lancaster Ave DWELLING 3 (LOTB)
92-94 Lancaster Avenue Punchbowl 2196
Canterbury-Bankstown Council
Deposited Plan 11831
37&38
-
separate dwelling house
5
572
275
135.0
20.0
125

Assessor number	n/a	
Certificate number	n/a	
Climate zone	n/a	
Area adjusted cooling load (MJ/m².year)	n/a	
Area adjusted heating load (MJ/m².year)	n/a	
Ceiling fan in at least one bedroom	n/a	
Ceiling fan in at least one living room or other conditioned area	n/a	
Project score		
Water	V 40	Target 40
Thermal Comfort	V Pass	Target Pass
Energy	50	Target 50

page 2/9

page 8/9

ter Commitments	Show on DA plans	Show on CC/CDC plans & specs	Certifier check
tures			
applicant must install showerheads with a minimum rating of 3 star (> 4.5 but <= 6 L/min) in all showers in the development.		~	~
applicant must install a toilet flushing system with a minimum rating of 4 star in each toilet in the development.		~	~
applicant must install taps with a minimum rating of 5 star in the kitchen in the development.		~	
applicant must install basin taps with a minimum rating of 5 star in each bathroom in the development.		 Image: A set of the set of the	
ernative water			
water tank			
applicant must install a rainwater tank of at least 3200 litres on the site. This rainwater tank must meet, and be installed in rdance with, the requirements of all applicable regulatory authorities.	~	~	~
applicant must configure the rainwater tank to collect rain runoff from at least 200 square metres of the roof area of the plopment (excluding the area of the roof which drains to any stormwater tank or private dam).		 Image: A set of the set of the	~
applicant must connect the rainwater tank to:			
at least one outdoor tap in the development (Note: NSW Health does not recommend that rainwater be used for human consumption in areas with potable water supply.)		 Image: A set of the set of the	~

ors and skyligh						
	ts					
		evices described in the table below ons must be satisfied for each win		~	 	~
The dwelling may have 1 skylight (<0.7 square metres) which is not listed in the table.					~	~
The following requirements must also be satisfied in relation to each window and glazed door:					~	~
and frame types, the	e certifier check can b	e performed by visual inspection.				Ĵ
ear						
air) clear						
lass single clear						
double (air) clear						
Maximum height (mm)	Maximum width (mm)	Туре	Shading Device (Dimen 10%)	sion within	Overshadowing	
600	2100	aluminium, single, clear	eave 450 mm, 200 mm al of window or glazed door		not overshadowed	
2200	800	aluminium, single, clear	eave 450 mm, 200 mm a of window or glazed door		not overshadowed	
2200	800	aluminium, single, clear	eave 450 mm, 200 mm all of window or glazed door		not overshadowed	
2200	800	aluminium, single, clear	eave 450 mm, 200 mm al of window or glazed door		not overshadowed	
2700	3000	aluminium, single, clear			not overshadowed	
2700	3000	aluminium, single, clear	verandah 2700 mm, 2700 base of window or glazed		not overshadowed	
	able. Relevant over kylight (<0.7 square s must also be satisf and frame types, the ear air) clear lass single clear s double (air) clear Maximum height (mm) 600 2200 2200 2200 2200	able. Relevant overshadowing specification kylight (<0.7 square metres) which is not is	able. Relevant overshadowing specifications must be satisfied for each winkylight (<0.7 square metres) which is not listed in the table.	able. Relevant overshadowing specifications must be satisfied for each window and glazed door. kylight (<0.7 square metres) which is not listed in the table.	able. Relevant overshadowing specifications must be satisfied for each window and glazed door. Image: Content of the section	able. Relevant overshadowing specifications must be satisfied for each window and glazed door. Image: Constraint overshadowing specifications must be satisfied in the table. kylight (<0.7 square metres) which is not listed in the table.

Window/glazed door no.	Maximum height (mm)	Maximum width (mm)	Туре	Shading Device (Dimension within 10%)	Overshadowing
South facing					
S01-ENS	900	600	aluminium, single, clear	eave 450 mm, 200 mm above head of window or glazed door	not overshadowed
West facing					
W01-B2	1200	2100	aluminium, single, clear	eave 450 mm, 200 mm above head of window or glazed door	not overshadowed
W02-B3	1200	2100	aluminium, single, clear	eave 450 mm, 200 mm above head of window or glazed door	not overshadowed
W03-B4	1200	2100	aluminium, single, clear	eave 450 mm, 200 mm above head of window or glazed door	not overshadowed

	Show on DA plans	Show on CC/CDC plans & specs	Certifier check
v and/or skylight in the kitchen of the dwelling for natural lighting.	~	~	~
v and/or skylight in 1 bathroom(s)/toilet(s) in the development for natural lighting.	~	~	~
oktop & electric oven in the kitchen of the dwelling.		 Image: A set of the set of the	
refrigerator space in the development so that it is "well ventilated", as defined in the BASIX		~	
utdoor clothes drying line as part of the development.		~	

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In these commitments, "applicant"	" means the person carrying out the development.
•	in the "Show on DA plans" column must be shown on the plans accompanelodged for the proposed development).
•	I in the "Show on CC/CDC plans and specs" column must be shown in the pent certificate for the proposed development.
Commitments identified with a final) for the development may be	In the "Certifier check" column must be certified by a certifying authority as issued.

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Notes 1. CONTRACTOR MUST VERIFY ALL DIMENSIONS ON SITE BEFORE COMMENCING WORK OR PREPARING SHOP DRAWINGS.

2. DO NOT SCALE DRAWINGS. 3. CONTRACTOR TO CHECK UNDERGROUND SERVICES BEFORE COMMENCING WORKS BY CONTACTING DIAL BEFORE YOU DIG. IF DIAL BEFORE YOU DIG INFORMATION IS PROVIDED WITH THIS DOCUMENTATION IT SHALL BE ASSUMED NOT TO BE CURRENT AND CONTRACTOR SHALL MAKE THEIR OWN ENQUIRES.



BASIX	Planning, Industry & Environment	www.basix.nsw.gov.au	Version: 3.0 / DARWINIA_3_20_0	Certificate No.: 1402126S	Wednesday, 27 September 2023

nying the development app	plication for the proposed development (if a	
plans and specifications a	ccompanying the application for a construction	
s having been fulfilled, bef	ore a final occupation certificate(either interim or	
ertificate No.: 1402126S	Wednesday, 27 September 2023	page 9

B DA SUBMISSION Rev Description

Project

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5/10/2023 ZB Date App'd

RESIDENTIAL DEVELOPMENT

92 & 94 Lancaster Ave Punchbowl NSW #Site Postcode Australia



Phone Number: +61 2 9745 2014 Nominated Architects:

Ziad Boumelhem Reg no 8008 Georges Jreije Reg no 10993 Drawing Title


COMPLIENCE BASIX COMMITMENTS 03

Scale 1:1.30

@A1 Sheet Size

Project Number 23-001 Status

BASIX COMMITMENTS 04 - LOT C, DWELLING C

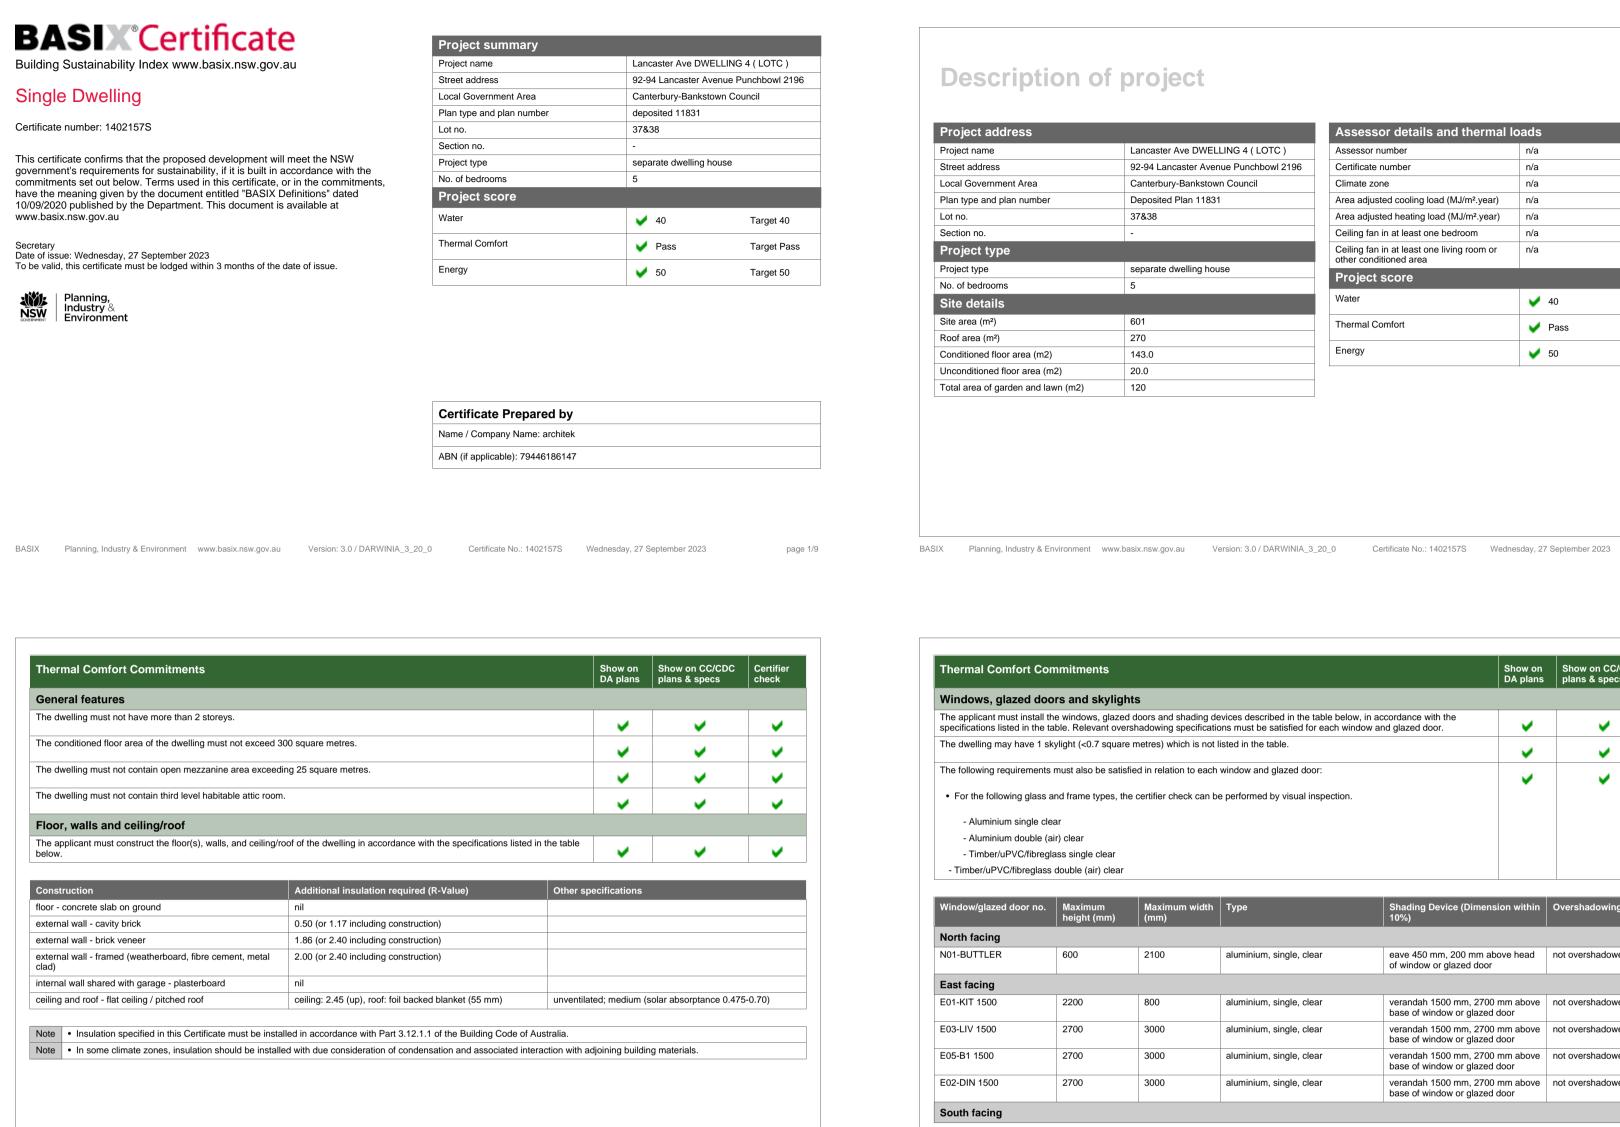

Show onShow on CC/CDCCertifieDA plansplans & specscheck Energy Commitments Hot water The applicant must install the following hot water system in the development, or a system with a higher energy rating: gas instantaneous with a performance of 3 stars. Cooling system The applicant must install the following cooling system, or a system with a higher energy rating, in at least 1 living area: 3-phase airconditioning; Energy rating: EER 3.0 - 3.5 Image: A set of the Image: A set of the The applicant must install the following cooling system, or a system with a higher energy rating, in at least 1 bedroom: 3-phase airconditioning; Energy rating: EER 3.0 - 3.5 • ~ The cooling system must provide for day/night zoning between living areas and bedrooms. Image: A second s ~ Heating system The living areas must not incorporate any heating system, or any ducting which is designed to accommodate a heating system. ✓ . ~ The bedrooms must not incorporate any heating system, or any ducting which is designed to accommodate a heating system. -**~** Ventilation The applicant must install the following exhaust systems in the development: At least 1 Bathroom: individual fan, ducted to façade or roof; Operation control: interlocked to light ~ ~~ Kitchen: no mechanical ventilation (ie. natural); Operation control: n/a ~~ Laundry: individual fan, ducted to façade or roof; Operation control: manual switch on/off -~ Artificial lighting The applicant must ensure that the "primary type of artificial lighting" is fluorescent or light emitting diode (LED) lighting in each of the following rooms, and where the word "dedicated" appears, the fittings for those lights must only be capable of accepting fluorescent or light emitting diode (LED) lamps: at least 4 of the bedrooms / study; ~ ~~ at least 2 of the living / dining rooms; ~ ~

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BASIX Planning, Industry & Environment www.basix.nsw.gov.au Version: 3.0 / DARWINIA_3_20_0 Certificate No.: 1402157S Wednesday, 27 September 2023

East facing E01-KIT 1500 2200 E03-LIV 1500 2700 E05-B1 1500 2700 E02-DIN 1500 2700 South facing BASIX Planning, Industry & Environment www.basix.nsw.gov.au Version: 3.0 / DARWINIA_3_20_0 Certificate No.: 1402157S Wednesday, 27 September 2023 **Energy Commitments** Natural lighting The applicant must install a window The applicant must install a window Other The applicant must install a gas cool The applicant must construct each r definitions. The applicant must install a fixed out

page 4/9

page 7/9

600

Description of project

Lancaster Ave DWELLING 4 (LOTC)
92-94 Lancaster Avenue Punchbowl 2196
Canterbury-Bankstown Council
Deposited Plan 11831
37&38
-
separate dwelling house
5
601
270
143.0
20.0
120

Assessor number	n/a	
Certificate number	n/a	
Climate zone	n/a	
Area adjusted cooling load (MJ/m².year)	n/a	
Area adjusted heating load (MJ/m².year)	n/a	
Ceiling fan in at least one bedroom	n/a	
Ceiling fan in at least one living room or other conditioned area	n/a	
Project score		
Water	V 40	Target 40
Thermal Comfort	V Pass	Target Pass
Energy	50	Target 50

page 2/9

page 8/9

Schedule of BASIX commitments
The commitments set out below regulate how the proposed development is to be carried out. It is development certificate issued, for the proposed development, that BASIX commitments be com
Water Commitments
Fixtures
The applicant must install showerheads with a minimum rating of 3 star (> 4.5 but <= 6 L/min) in all shower
The applicant must install a toilet flushing system with a minimum rating of 4 star in each toilet in the devel
The applicant must install taps with a minimum rating of 5 star in the kitchen in the development.
The applicant must install basin taps with a minimum rating of 5 star in each bathroom in the development
Alternative water
Rainwater tank
The applicant must install a rainwater tank of at least 3200 litres on the site. This rainwater tank must mee accordance with, the requirements of all applicable regulatory authorities.
The applicant must configure the rainwater tank to collect rain runoff from at least 200 square metres of th development (excluding the area of the roof which drains to any stormwater tank or private dam).
The applicant must connect the rainwater tank to:
 at least one outdoor tap in the development (Note: NSW Health does not recommend that rainwater be consumption in areas with potable water supply.)

ents				Show on DA plans	Show on CC/CDC plans & specs	Certifier check
d skylight	s					
		evices described in the table below, i ons must be satisfied for each windo		~	~	~
c0.7 square metres) which is not listed in the table.			~	~	~	
so be satisfie	ed in relation to each	window and glazed door:		~	~	~
e types, the	certifier check can be	e performed by visual inspection.				
le clear						
(air) clear						
mum nt (mm)	Maximum width (mm)	Туре	Shading Device (Dime 10%)	nsion within	Overshadowing	
	2100	aluminium, single, clear	eave 450 mm, 200 mm of window or glazed do		not overshadowed	
	800	aluminium, single, clear	verandah 1500 mm, 27 base of window or glaze		not overshadowed	
	3000	aluminium, single, clear	verandah 1500 mm, 27 base of window or glaze		not overshadowed	
	3000	aluminium, single, clear	verandah 1500 mm, 27 base of window or glaze		not overshadowed	
	3000	aluminium, single, clear	verandah 1500 mm, 27 base of window or glaze		not overshadowed	

Window/glazed door no.	Maximum height (mm)	Maximum width (mm)	Туре	Shading Device (Dimension within 10%)	Overshadowing
S01-ENS	900	600	aluminium, single, clear	eave 450 mm, 200 mm above head of window or glazed door	not overshadowed
West facing					
W02-B3	1200	2100	aluminium, single, clear	eave 450 mm, 200 mm above head of window or glazed door	not overshadowed
W01-B2	1200	2100	aluminium, single, clear	eave 450 mm, 200 mm above head of window or glazed door	not overshadowed
W03-B4	1200	2100	aluminium, single, clear	eave 450 mm, 200 mm above head of window or glazed door	not overshadowed

	Show on DA plans	Show on CC/CDC plans & specs	Certifier check
	DA plans	pians a specs	CHECK
w and/or skylight in the kitchen of the dwelling for natural lighting.	~	~	~
w and/or skylight in 1 bathroom(s)/toilet(s) in the development for natural lighting.	~	~	~
poktop & electric oven in the kitchen of the dwelling.		 	
n refrigerator space in the development so that it is "well ventilated", as defined in the BASIX		~	
outdoor clothes drying line as part of the development.		~	
	1	1	1

BASIX Planning, Industry & Environment www.basix.nsw.gov.au Version: 3.0 / DARWINIA_3_20_0 Certificate No.: 1402157S Wednesday, 27 September 2023

In these	e commitme	ents, "applicant" me	ans the person car	ying out the develop	ment.	
		•			shown on the plans ac	companyi
		cation is to be lodge				
				DC plans and specs" posed development.	column must be show	ו in the pla
		tified with a 🥪 in th opment may be issu		column must be cert	ified by a certifying aut	hority as h

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Notes 1. CONTRACTOR MUST VERIFY ALL DIMENSIONS ON SITE BEFORE COMMENCING WORK OR PREPARING SHOP DRAWINGS.

2. DO NOT SCALE DRAWINGS. 3. CONTRACTOR TO CHECK UNDERGROUND SERVICES BEFORE COMMENCING WORKS BY CONTACTING DIAL BEFORE YOU DIG. IF DIAL BEFORE YOU DIG INFORMATION IS PROVIDED WITH THIS DOCUMENTATION IT SHALL BE ASSUMED NOT TO BE CURRENT AND CONTRACTOR SHALL MAKE THEIR OWN ENQUIRES.



Water Commitments	Show on DA plans	Show on CC/CDC plans & specs	Certifi check
Fixtures			
The applicant must install showerheads with a minimum rating of 3 star (> 4.5 but <= 6 L/min) in all showers in the development.		~	~
The applicant must install a toilet flushing system with a minimum rating of 4 star in each toilet in the development.		 Image: A set of the set of the	-
The applicant must install taps with a minimum rating of 5 star in the kitchen in the development.		>	
The applicant must install basin taps with a minimum rating of 5 star in each bathroom in the development.		 Image: A second s	
Alternative water			
Rainwater tank			
The applicant must install a rainwater tank of at least 3200 litres on the site. This rainwater tank must meet, and be installed in accordance with, the requirements of all applicable regulatory authorities.	~	~	~
The applicant must configure the rainwater tank to collect rain runoff from at least 200 square metres of the roof area of the development (excluding the area of the roof which drains to any stormwater tank or private dam).		 Image: A set of the set of the	~
The applicant must connect the rainwater tank to:			
 at least one outdoor tap in the development (Note: NSW Health does not recommend that rainwater be used for human consumption in areas with potable water supply.) 		 Image: A set of the set of the	~

BASIX	Planning, Industry & Environment	www.basix.nsw.gov.au	Version: 3.0 / DARWINIA_3_20_0	Certificate No.: 1402157S	Wednesday, 27 September 2023

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B DA SUBMISSION Rev Description

Project

5/10/2023 ZB Date App'd

RESIDENTIAL DEVELOPMENT

92 & 94 Lancaster Ave Punchbowl NSW #Site Postcode Australia



Phone Number: +61 2 9745 2014 Nominated Architects:

Ziad Boumelhem Reg no 8008 Georges Jreije Reg no 10993 Drawing Title


COMPLIENCE **BASIX COMMITMENTS 04**

Scale 1:1.30

@A1 Sheet Size

Project Number 23-001 Status

Drawing Number

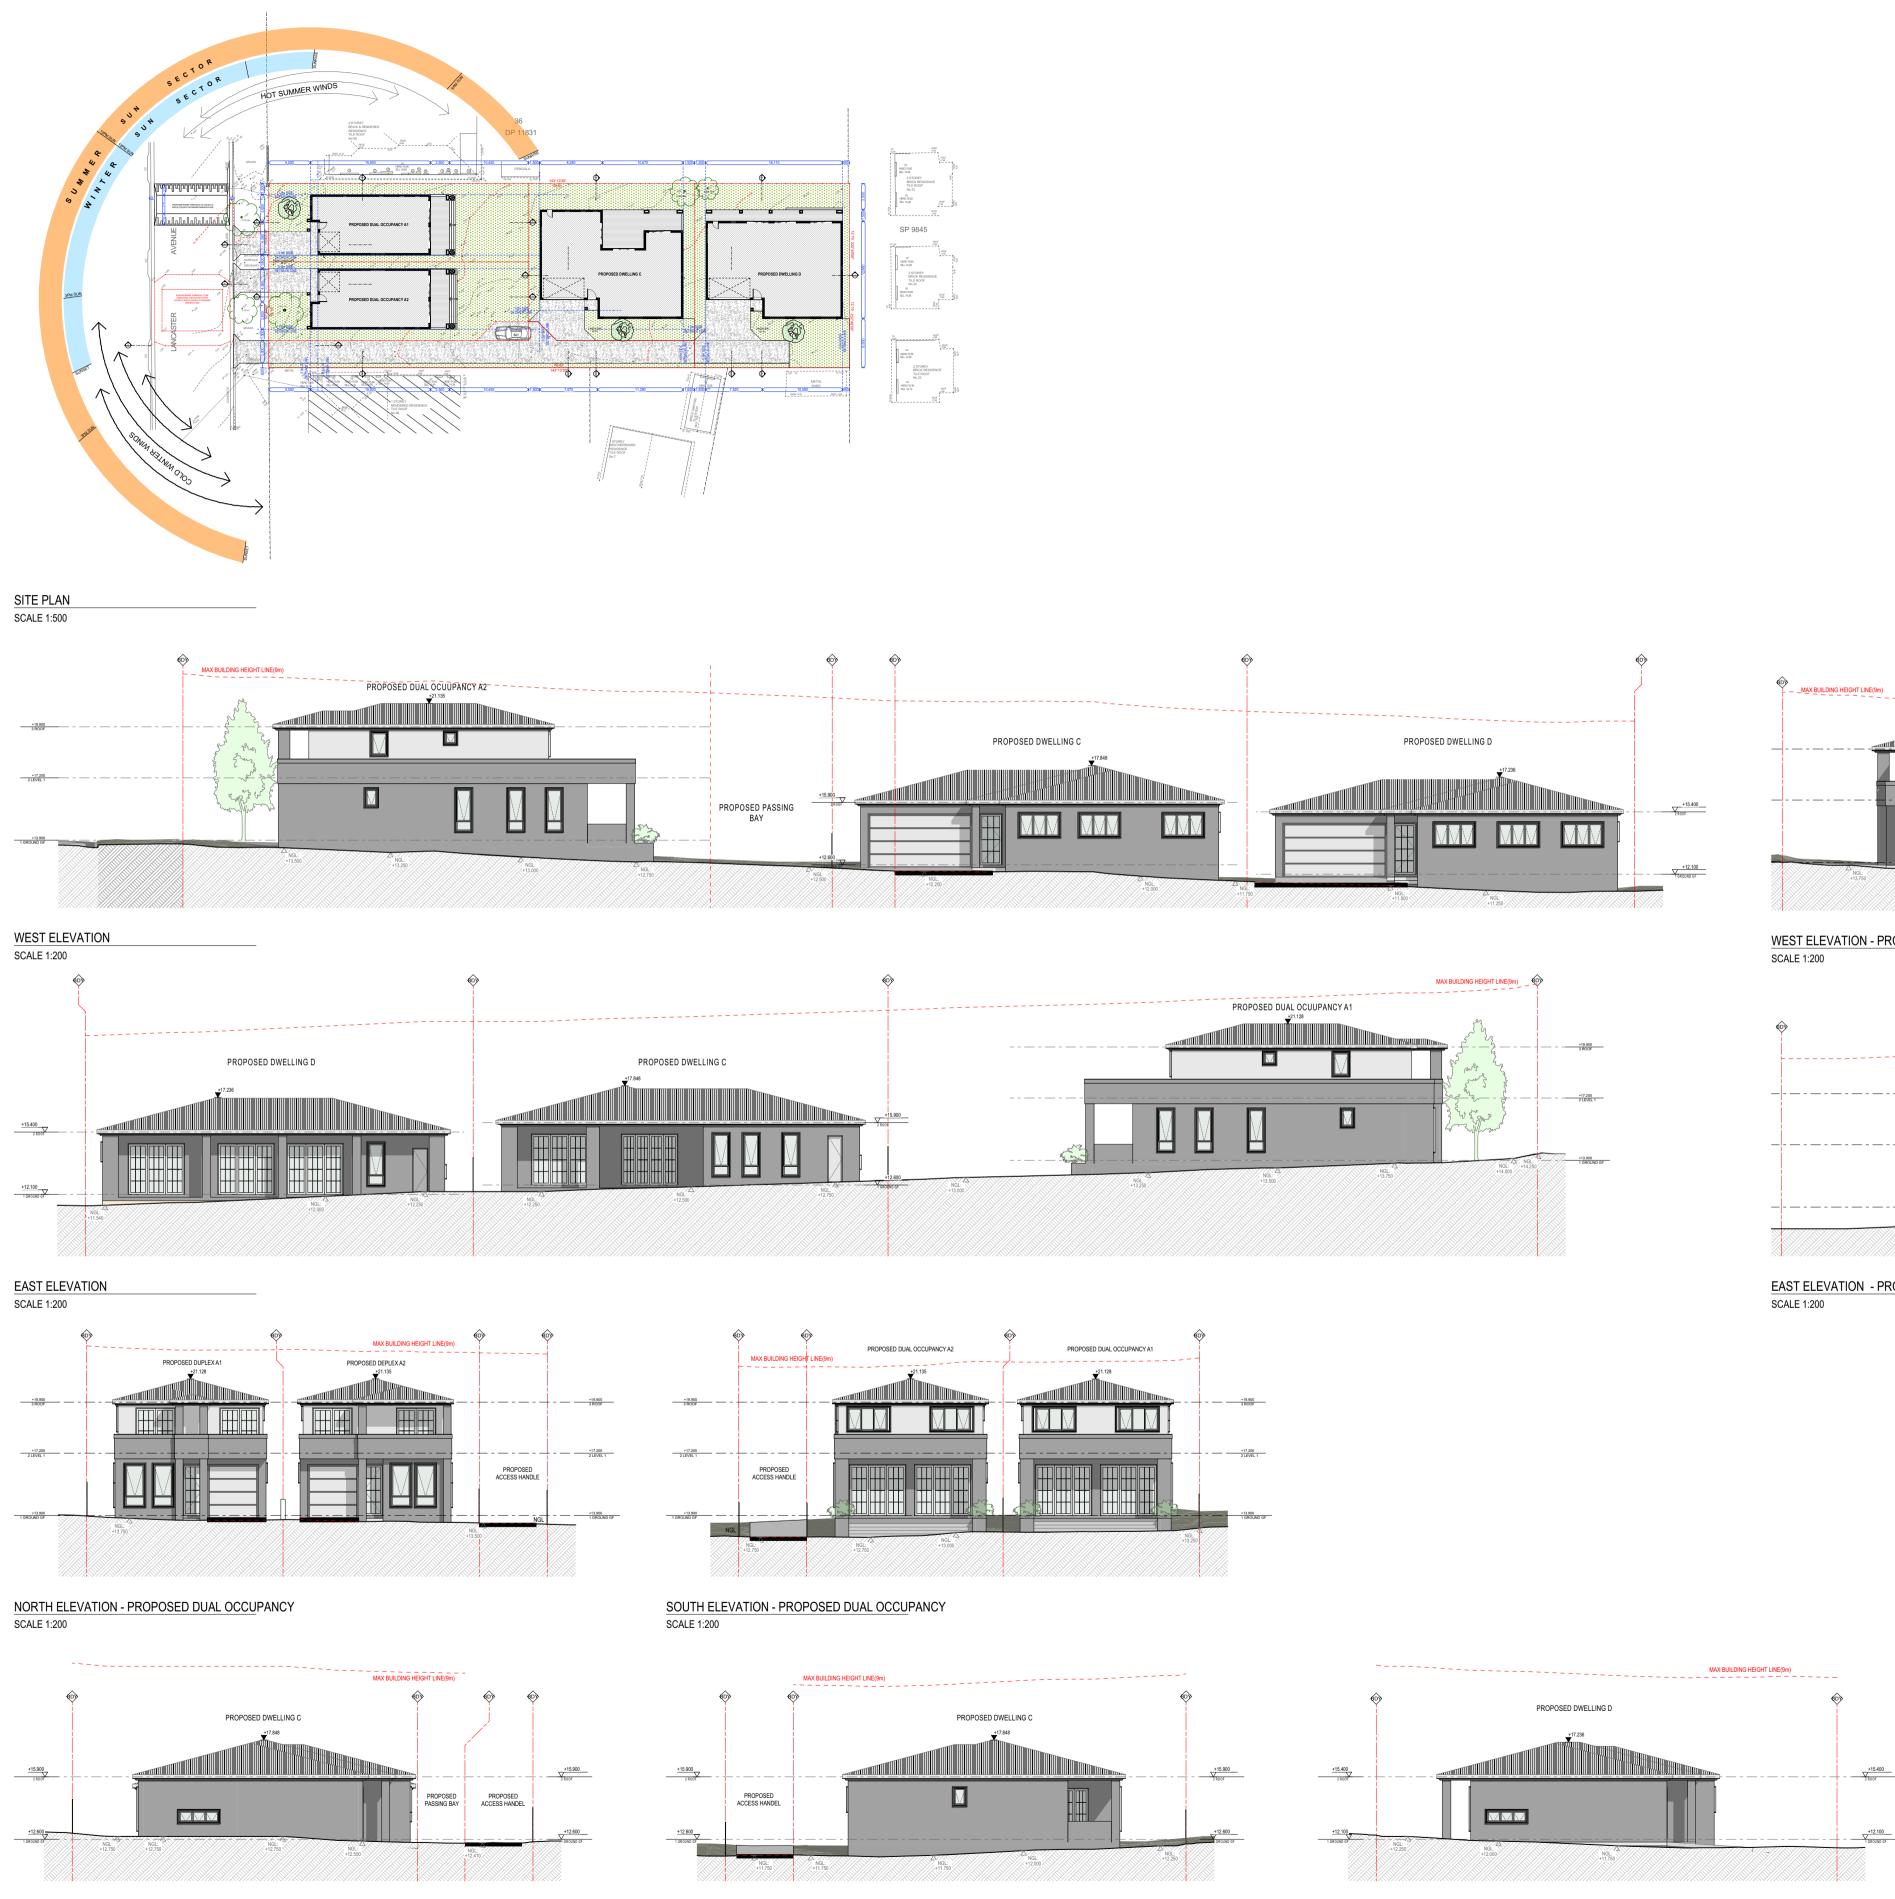


NORTH ELEVATION - PROPOSED DWELLING C SCALE 1:200

SOUTH ELEVATION - PROPOSED DWELLING C SCALE 1:200





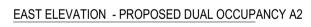

_____ MAX BUILDING HEIGHT LINE(9m) (D) +15.400 +12.100

NORTH ELEVATION - PROPOSED DWELLING D SCALE 1:200


SOUTH ELEVATION - PROPOSED DWELLING D SCALE 1:200


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Notes 1. CONTRACTOR MUST VERIFY ALL DIMENSIONS ON SITE BEFORE COMMENCING WORK OR PREPARING SHOP DRAWINGS.

 DO NOT SCALE DRAWINGS.
 DO NOT SCALE DRAWINGS.
 CONTRACTOR TO CHECK UNDERGROUND SERVICES BEFORE COMMENCING WORKS BY CONTACTING DIAL BEFORE YOU DIG. IF DIAL BEFORE YOU DIG INFORMATION IS PROVIDED WITH THIS DOCUMENTATION IT SHALL BE ASSUMED NOT TO BE CURRENT AND CONTRACTOR SHALL MAKE THEIR OWN ENQUIRES.






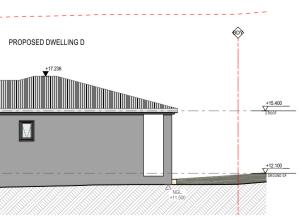

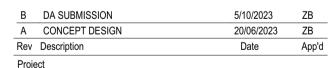RESIDENTIAL DEVELOPMENT

92 & 94 Lancaster Ave Punchbowl NSW #Site Postcode Australia

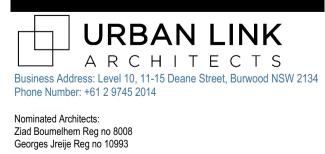

Drawing Title COMPLIENCE

NEIGHBOUR NOTIFICATION PLAN

Scale 1:200, 1:500 @A1 Sheet Size

Project Number

23-001

Status

















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LEXICON® QUARTER SW1E1 OR SIMILAR BY: DULUX



Α

TICKING SG6G7 OR SIMILAR BY: DULUX



SURFMIST[®] COLORBOND ROOF OR SIMILAR BY: COLORBOND®



LAMDSCAPE REFER TO LANDSCAPE PLAN & LANDSCAPE SCHEDULE



PLANTER BOX COVERED WITH REINFORCING MESH AND COATED WITH DURABLE FLEXCRETE



ANONDISED ALUMINIUM FRAME WINDOWS/DOORS WITH GLAZING TO BASIX'S SPECIFICATIONS

В	DA SUBMISSION	5/10/2023	ZB
Α	CONCEPT DESIGN	20/06/2023	ZB
Rev	Description	Date	App'd

Project **RESIDENTIAL DEVELOPMENT**

92 & 94 Lancaster Ave Punchbowl NSW #Site Postcode Australia



Scale

Project Number

23-001

Status

@A1 Sheet Siz

Drawing Number

DA-0501

Revision В